PROPOSED SINGLE STORY A DDITION

360 TAHQUITZ STREET SAN JACINTO, CA 92583

OWNER: DRAFTING J A. FLOR 11145 WA EL MONT		S	STRUCT. ENG:	TITLE 24: NRG COMPLIANCE INC.		GRAL. CONTRACTOR:		
GENERAL NOTES:					VICINITY N	1AP		
THE OWNER/CONTRACTOR SHALL VERIFY ALL EXISTING MENSIONS AND ELEVATIONS BEFORE PROCEEDING WITTORK. DO NOT SCALE DRAWINGS. ALL DIMENSIONS ARE TO FACE STUDS, CONCRETE BLCTUDS.	TH ANY CONSTRUCTION	CONCRETE DESIGNED W/ F'C GF CONCRETE. 16. CONTINOUS INSPECTION BY STREGHT BOLTS.	A DEPUTY INSPECTOR IS REQUIRED FOR ALL REATER THAN 2500 PSI. AT GRADE BEAM A DEPUTY INSPECTOR REQUIRED FOR HIGH DLORS, AND ALL OTHER DECORATIVE MATERIAL	N State St	N. Parn	Borried Ards		

- 1. ALL WORK, CONSTRUCTION, AND MATERIALS SHALL COMPLY WITH ALL PROVISION OF THE BUILDING CODE AND WITH OTHER RULES, COVERING THE PLACE OF THE BUILDING PROJECT. LOCAL BUILDING CODE REQUIREMENTS TAKE PRECEDENCE OVER THE DRAWINGS AND IT SHALL BE THE RESPONSIBILITY OF ANYONE SUPPLYING LABOR OR MATERIALS OR BOTH TO BRING TO THE ATTENTION OF THE OWNER OF ANY DISCREPANCIES OR CONFLICTS BETWEEN REOUIREMENTS OF THE CODE AND DRAWINGS.
- 5. REFERENCE TO ANY DETAILS OR DRAWING IS FOR CONVENIENCE ONLY AND DOES NOT LIMIT THE APPLICATION OF SUCH DETAIL OR DRAWING. 6. DISCREPANCIES IN THE DRAWINGS OR BETWEEN THE DRAWING AND ACTUAL FIELD CONDITIONS SHALL BE REPORTED TO THE OWNER. CORRECTED DRAWINGS OR INSTRUCTIONS SHALL BE ISSUED BY THE OWNER PRIOR TO THE INSTALLATION OF ANY WORK.
- 7. THE OWNER IS RESPONSIBLE FOR ALL WORK SHOWN ON THESE DRAWINGS AND SPECIFICATIONS UNLESS SPECIFICALLY NOTED OTHERWISE. 8. THE CONTRACT DRAWINGS AND SPECIFICATIONS REPRESENT THE FINISHED STRUCTURE UNLESS OTHERWISE SHOWN. THEY DO NOT INDICATE THE METHOD OF CONSTRUCTION. THE OWNER SHALL SUPERVISE AND DIRECT THE WORK AND HE SHALL BE SOLELY RESPONSIBLE FOR ALL CONSTRUCTION MEANS, METHODS, TECHNIQUES, SEQUENCES, PROCEDURES, TO ACHIEVED THE FINISHED STRUCTURE.
- 9. MAINTAIN SANITARY TOILET FACILITIES DURING CONSTRUCTION AS REQUIRED BY APPLICABLE REGULATIONS.
- 10. IT SHALL BE THE RESPONSIBILITY OF THE CONTRACTOR FOR COORDINATING HIS WORK AND/OR EQUIPMENT SUPPLIED BY THE CONTRACTOR.
- 11. THE DESIGNER/DRAFTER WILL NOT BE RESPONSIBLE FOR ANY ACTION TAKEN BY ANYONE ON THE PROJECT IF THAT PERSON IS KNOWLEDGEABLE OF ANY DISCREPANCIES, OMISSIONS, OR AMBIGUITY IN THE DRAWINGS OR SPECIFICATIONS UNTIL THE DESIGNER/DRAFTER HAS BEEN NOTIFIED, HAS CORRECTED THE DISCREPANCY OR MORE CLEARLY EXPLAINED THE CONTENTS OF THE DRAWINGS OR SPECIFICATIONS.
- 12. GLAZING MATERIALS AND INSTALLATION SHALL BE IN ACCORDANCE SPECIFICATIONS SECTION 08800 AND U.B.C. SEC. 3312 AND SEC. 3314 13. FIXED WINDOWS SHALL BE SEALED TO LIMIT AIR INFILTRATION. ALL DOORS SHALL LIMIT AIR LEAKAGE AROUND THEIR PERIMETER WHEN IN A CLOSE POSITION PROVIDE SEAL OR ASTRAGAL AT THE HEAD, SILL AND WALL JAMBS. OPEN EXTERIOR JOINTS AROUND WINDOW AND DOOR FRAMES, BETWEEN WALL AND ROOF, BETWEEN PANELS AND AT PENETRATIONS OF UTILITIES THRU ENVELOPE SHALL BE SEALED, CAULK OR WHEATHER STRIPPED TO LIMIT AIR LEAKAGE.
- 14. IF REQUIRED BY THE BUILDING INSPECTOR, A PROTECTION FENCE SHALL BE CONSTRUCTED AND MAINTAINED CONFORMING TO THE REQUIREMENTS OF THE THE BUILDING CODE.

- TO BE DETERMINED BY OWNER.
- 18. ALL WORK IN THE PUBLIC RIGHT OF WAY SHALL BE DONE PER CITY STANDARDS.
- 19. GOVERNING CODES FOR THIS PROJECT ARE THE 2001 CALIFORNIA BUILDING (CBC), ELECTRICAL (CEC), ENERGY (T24-6), MECHANICAL (CMC), AND PLUMBING (CPC) CODES WITH LOCAL AMENDMENTS.

STRUCTURAL OBSERVATION WILL BE PERFORMED WHEN REQUIRED BY THE **BUILDING OFFICIAL**

REQUIRED SPECIAL INSPECTIONS:

-IN ADDITION TO THE REGULAR INSPECTIONS, THE FOLLOWING ITEMS WILL ALSO REQUIRE SPECIAL INSPECTION IN ACCORDANCE WITH SEC.1701 UBC

EPOXY ANCHORS, SPECIAL INSPECTION REQUIRED (SEE SPECIAL INSPECTION PROGRAM)

Artesia W 1st St E 2nd St W 2nd St E 3rd

BUILDING SUMMARY

1702 SF

6041 SF

SHEET INDEX

- A 0.1 TITLE SHEET
- A 0.2 TITLE 24
- A 0.3 TITLE 24
- A 0.4 TITLE 24
- A 0.5 TITLE 24 A 0.6 TITLE 24
- A 0.7 WINDOW&DOOR SCHEDULES
- A 1.1 SITE PLAN
- A 1.2 FIRST FLOOR PLAN
- A 1.3 ROOF PLAN A 1.4 FOUNDATION PLAN
- A_1.5 FRAMING PLAN
- A 1.6 UTILITIES PLAN
- A 2.1 ELEVATIONS
- A_2.2 ELEVATIONS
- A_3.1 SECTION
- S 1.1 DETAILS
- S_1.2 DETAILS

EXISTING HOUSE:

FIRST FLOOR 925 SF LIVING AREA 280 SF CARPORT AREA

PROPOSED ADDITION:

1322 SF LIVING AREA 380 SF GARAGE

TOTAL PROPOSED NEW CONSTRUCTION:

LOT SIZE:

PROPOSED RESIDENCE **EXISTING & ADDITION:**

2627 SF (INCLUDING GARAGE)

LOT COVERAGE 43%

360 TAHQUITZ STREET LOT NO.


ZONNING:

TYPE OF CONSTRUCTION: **OCCUPANCY:**

SHEET NO:

			ID I	MANUFACTURE	FRAME	WxH		ТҮРЕ		REMARKS
		NEW	1			3'-0"X6'-8"	SOLID W	/OOD		EXTERIOR DOOR WITH LOCK-SET/HARDWARE
		NEW	2			2'-6"X6'-8"	SOLID W	OOD/SELF CLO	SING	20 MIN. FIRE RATED DOOR WITH LOCK-SET/HARDWARE
		NEW	3			2'-4"X6'-8"	SOLID W	OOD/SELF CLO	SING	20 MIN. FIRE RATED DOOR WITH LOCK-SET/HARDWARE
		NEW	4			2'-4"X6'-8"	HOLLOW	V WOOD		INTERIOR DOOR WITH HARDWARE
	CHEDULE	EXIST.	5			2'-4"X6'-8"	HOLLOW	/ WOOD		INTERIOR DOOR WITH HARDWARE
	S		6			3'-0"X6'-8"	SOLID W	'OOD		EXTERIOR DOOR WITH LOCK-SET/HARDWARE
		NEW (7)			2'-6"X6'-8"		8" SOLID WOOD			EXTERIOR DOOR WITH LOCK-SET/HARDWARE
										LOCK SEI/TI/(IIDW/(IIL
			ID 1	MANUFACTURE	STYLE	WxH	FRAME	GLAZING	SCREEN	REMARKS
		NEW	(A)	ŀ	HORIZ. SLIDE	6'-0"X4'-0"	ALUM.	DOUBLE	FULL	U-FACTOR: .600, SHGC: .65
			B	,	VERT. SLIDE	3'0"X4'-0"	ALUM.	DOUBLE/ TEMPERED	FULL	U EACTOD, 600 SUCC, 65
					12.11.02.02					U-FACTOR: .600, SHGC: .65
		NEW	<u>C</u>	ŀ	HORIZ. SLIDE		ALUM.	DOUBLE/	FULL	U-FACTOR: .600, SHGC: .65
			(C) (D)			3'-0"X2'-0"	ALUM.		FULL FULL	
		NEW		\	HORIZ. SLIDE	3'-0"X2'-0" 3'-0"X4'-0"		DOUBLE/ TEMPERED		U-FACTOR: .600, SHGC: .65
		NEW	D	\ 	HORIZ. SLIDE VERT. SLIDE	3'-0"X2'-0" 3'-0"X4'-0" 3'-0"X3'-0"	ALUM.	DOUBLE/ TEMPERED DOUBLE	FULL	U-FACTOR: .600, SHGC: .65 U-FACTOR: .600, SHGC: .65
	' SCHEDULE	NEW NEW	D E		HORIZ. SLIDE VERT. SLIDE HORIZ. SLIDE HORIZ. SLIDE	3'-0"X2'-0" 3'-0"X4'-0" 3'-0"X3'-0"	ALUM.	DOUBLE/ TEMPERED DOUBLE	FULL	U-FACTOR: .600, SHGC: .65 U-FACTOR: .600, SHGC: .65
NOTE:	ADOW SCHEDULE	NEW NEW EXIST.	DEF	\	HORIZ. SLIDE VERT. SLIDE HORIZ. SLIDE HORIZ. SLIDE	3'-0"X2'-0" 3'-0"X4'-0" 3'-0"X3'-0" 4'-0"X4'-0" 3'-0"X1'-8"	ALUM. ALUM.	DOUBLE/ TEMPERED DOUBLE DOUBLE DOUBLE	FULL FULL	U-FACTOR: .600, SHGC: .65 U-FACTOR: .600, SHGC: .65
NOTE: ALL NEW GLAZING WHALL COMPLY WITH STANDARDS OF THE U.S. CONSUMER	WINDOW SCHEDULE	NEW NEW EXIST.	DEFG		HORIZ. SLIDE VERT. SLIDE HORIZ. SLIDE HORIZ. SLIDE UP HUNG	3'-0"X2'-0" 3'-0"X4'-0" 4'-0"X4'-0" 3'-0"X1'-8" 5'-0"X4'-0"	ALUM. ALUM. ALUM.	DOUBLE/TEMPERED DOUBLE DOUBLE DOUBLE DOUBLE	FULL FULL FULL	U-FACTOR: .600, SHGC: .65 U-FACTOR: .600, SHGC: .65 U-FACTOR: .600, SHGC: .65 U-FACTOR: .600, SHGC: .65
ALL NEW GLAZING WHALL COMPLY WITH STANDARDS OF THE U.S. CONSUMER PRODUCT SAFETY COMMISSION. MANUFACTURERS TO SUPPLY	WINDOW SCHEDULE	NEW NEW EXIST. NEW NEW	(E) (F) (G) (H)		HORIZ. SLIDE VERT. SLIDE HORIZ. SLIDE HORIZ. SLIDE UP HUNG HORIZ. SLIDE VERT. SLIDE	3'-0"X2'-0" 3'-0"X4'-0" 4'-0"X4'-0" 3'-0"X1'-8" 5'-0"X4'-0" 2'-8"X3'-0"	ALUM. ALUM. ALUM. ALUM.	DOUBLE/TEMPERED DOUBLE DOUBLE DOUBLE DOUBLE DOUBLE	FULL FULL FULL FULL	U-FACTOR: .600, SHGC: .65 U-FACTOR: .600, SHGC: .65 U-FACTOR: .600, SHGC: .65 U-FACTOR: .600, SHGC: .65
ALL NEW GLAZING WHALL COMPLY WITH STANDARDS OF THE U.S. CONSUMER PRODUCT SAFETY COMMISSION.	WINDOW SCHEDULE	NEW NEW EXIST. NEW EXIST.	(F) (G) (H) (J)		HORIZ. SLIDE VERT. SLIDE HORIZ. SLIDE HORIZ. SLIDE UP HUNG HORIZ. SLIDE VERT. SLIDE	3'-0"X2'-0" 3'-0"X4'-0" 4'-0"X4'-0" 3'-0"X1'-8" 5'-0"X4'-0" 2'-8"X3'-0"	ALUM. ALUM. ALUM. ALUM. ALUM.	DOUBLE DOUBLE DOUBLE DOUBLE DOUBLE DOUBLE DOUBLE DOUBLE	FULL FULL FULL FULL FULL	U-FACTOR: .600, SHGC: .65 U-FACTOR: .600, SHGC: .65 U-FACTOR: .600, SHGC: .65 U-FACTOR: .600, SHGC: .65
ALL NEW GLAZING WHALL COMPLY WITH STANDARDS OF THE U.S. CONSUMER PRODUCT SAFETY COMMISSION. MANUFACTURERS TO SUPPLY CERTIFICATE OF COMPLIANCE TO THE	WINDOW SCHEDULE	NEW NEW EXIST. NEW EXIST.	(E) (F) (G) (H) (J) (K)		HORIZ. SLIDE VERT. SLIDE HORIZ. SLIDE UP HUNG HORIZ. SLIDE VERT. SLIDE VERT. SLIDE	3'-0"X2'-0" 3'-0"X4'-0" 4'-0"X4'-0" 3'-0"X1'-8" 5'-0"X4'-0" 2'-8"X3'-0"	ALUM. ALUM. ALUM. ALUM. ALUM. ALUM.	DOUBLE/TEMPERED DOUBLE DOUBLE DOUBLE DOUBLE DOUBLE DOUBLE DOUBLE DOUBLE	FULL FULL FULL FULL FULL FULL	U-FACTOR: .600, SHGC: .65 U-FACTOR: .600, SHGC: .65 U-FACTOR: .600, SHGC: .65 U-FACTOR: .600, SHGC: .65 U-FACTOR: .600, SHGC: .65
ALL NEW GLAZING WHALL COMPLY WITH STANDARDS OF THE U.S. CONSUMER PRODUCT SAFETY COMMISSION. MANUFACTURERS TO SUPPLY CERTIFICATE OF COMPLIANCE TO THE	WINDOW SCHEDULE	NEW NEW EXIST. NEW EXIST.	(E) (F) (G) (H) (J) (K)		HORIZ. SLIDE VERT. SLIDE HORIZ. SLIDE UP HUNG HORIZ. SLIDE VERT. SLIDE VERT. SLIDE	3'-0"X2'-0" 3'-0"X4'-0" 4'-0"X4'-0" 3'-0"X1'-8" 5'-0"X4'-0" 2'-8"X3'-0"	ALUM. ALUM. ALUM. ALUM. ALUM. ALUM.	DOUBLE/TEMPERED DOUBLE DOUBLE DOUBLE DOUBLE DOUBLE DOUBLE DOUBLE DOUBLE	FULL FULL FULL FULL FULL FULL	U-FACTOR: .600, SHGC: .65 U-FACTOR: .600, SHGC: .65 U-FACTOR: .600, SHGC: .65 U-FACTOR: .600, SHGC: .65 U-FACTOR: .600, SHGC: .65


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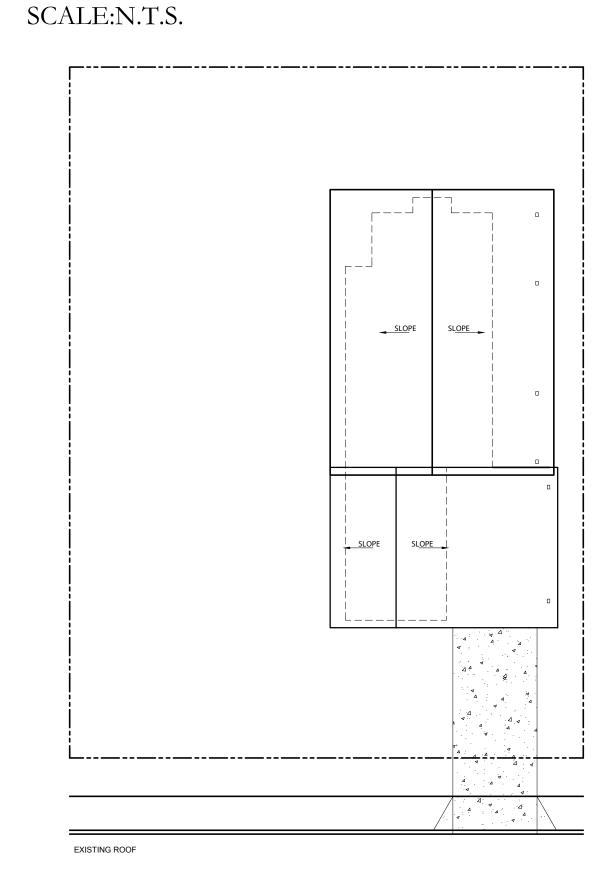
SLOPE SL<u>OPE</u> **■** SLOPE SL<u>OPE</u> PROPOSED ROOF

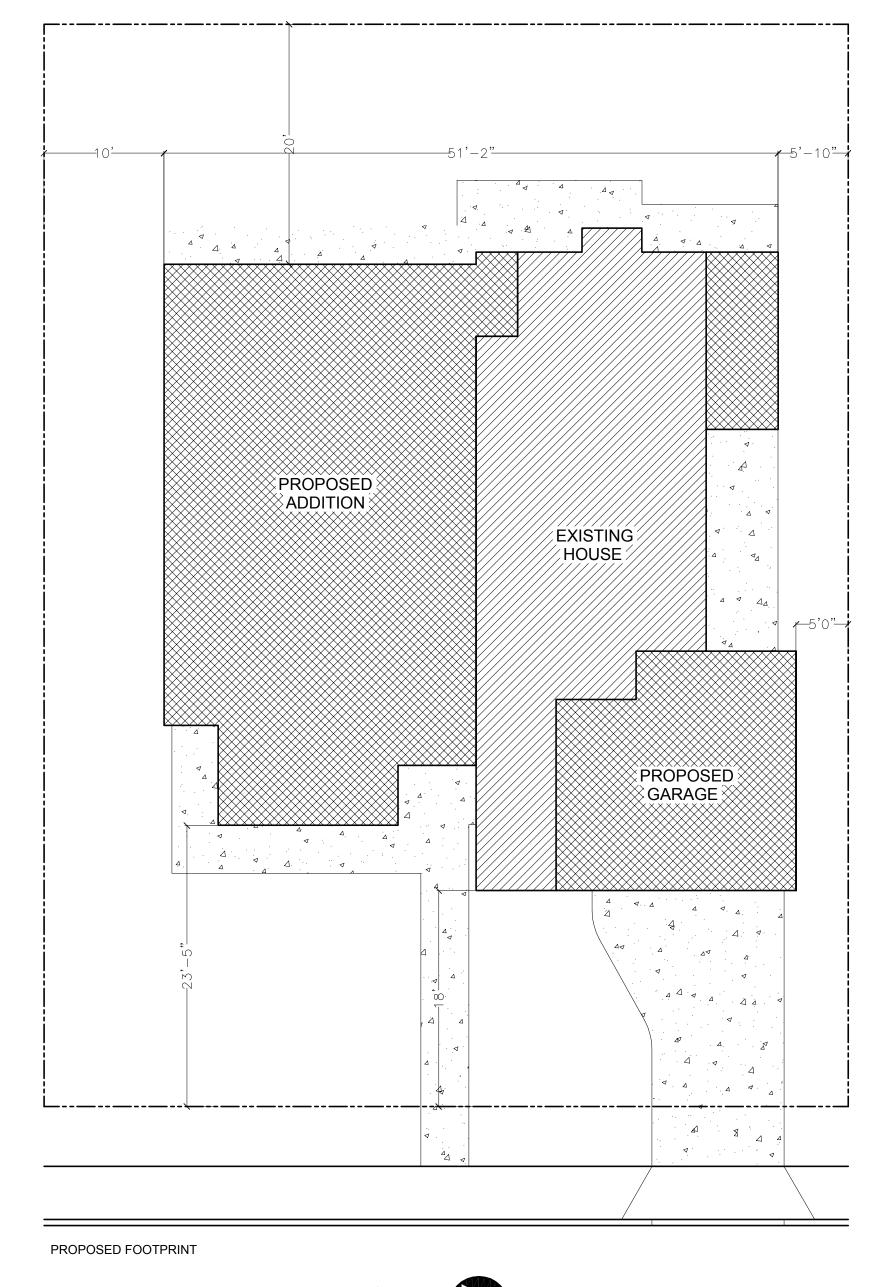PROPOSED ROOF LINE

SCALE:1/8"=1'-0"



EXISTING SITE PLAN

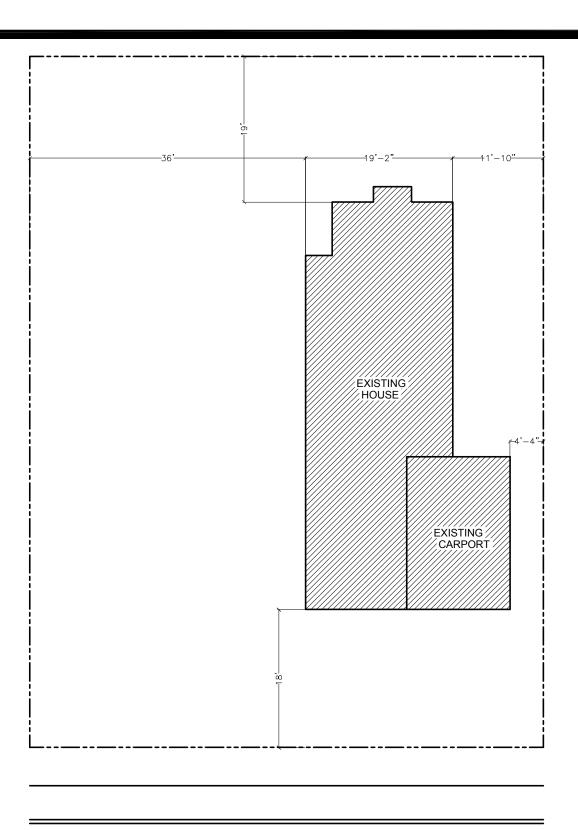


EXISTING ROOF LINE SCALE:N.T.S.


PROPOSED SITE PLAN SCALE:1/8"=1'-0"



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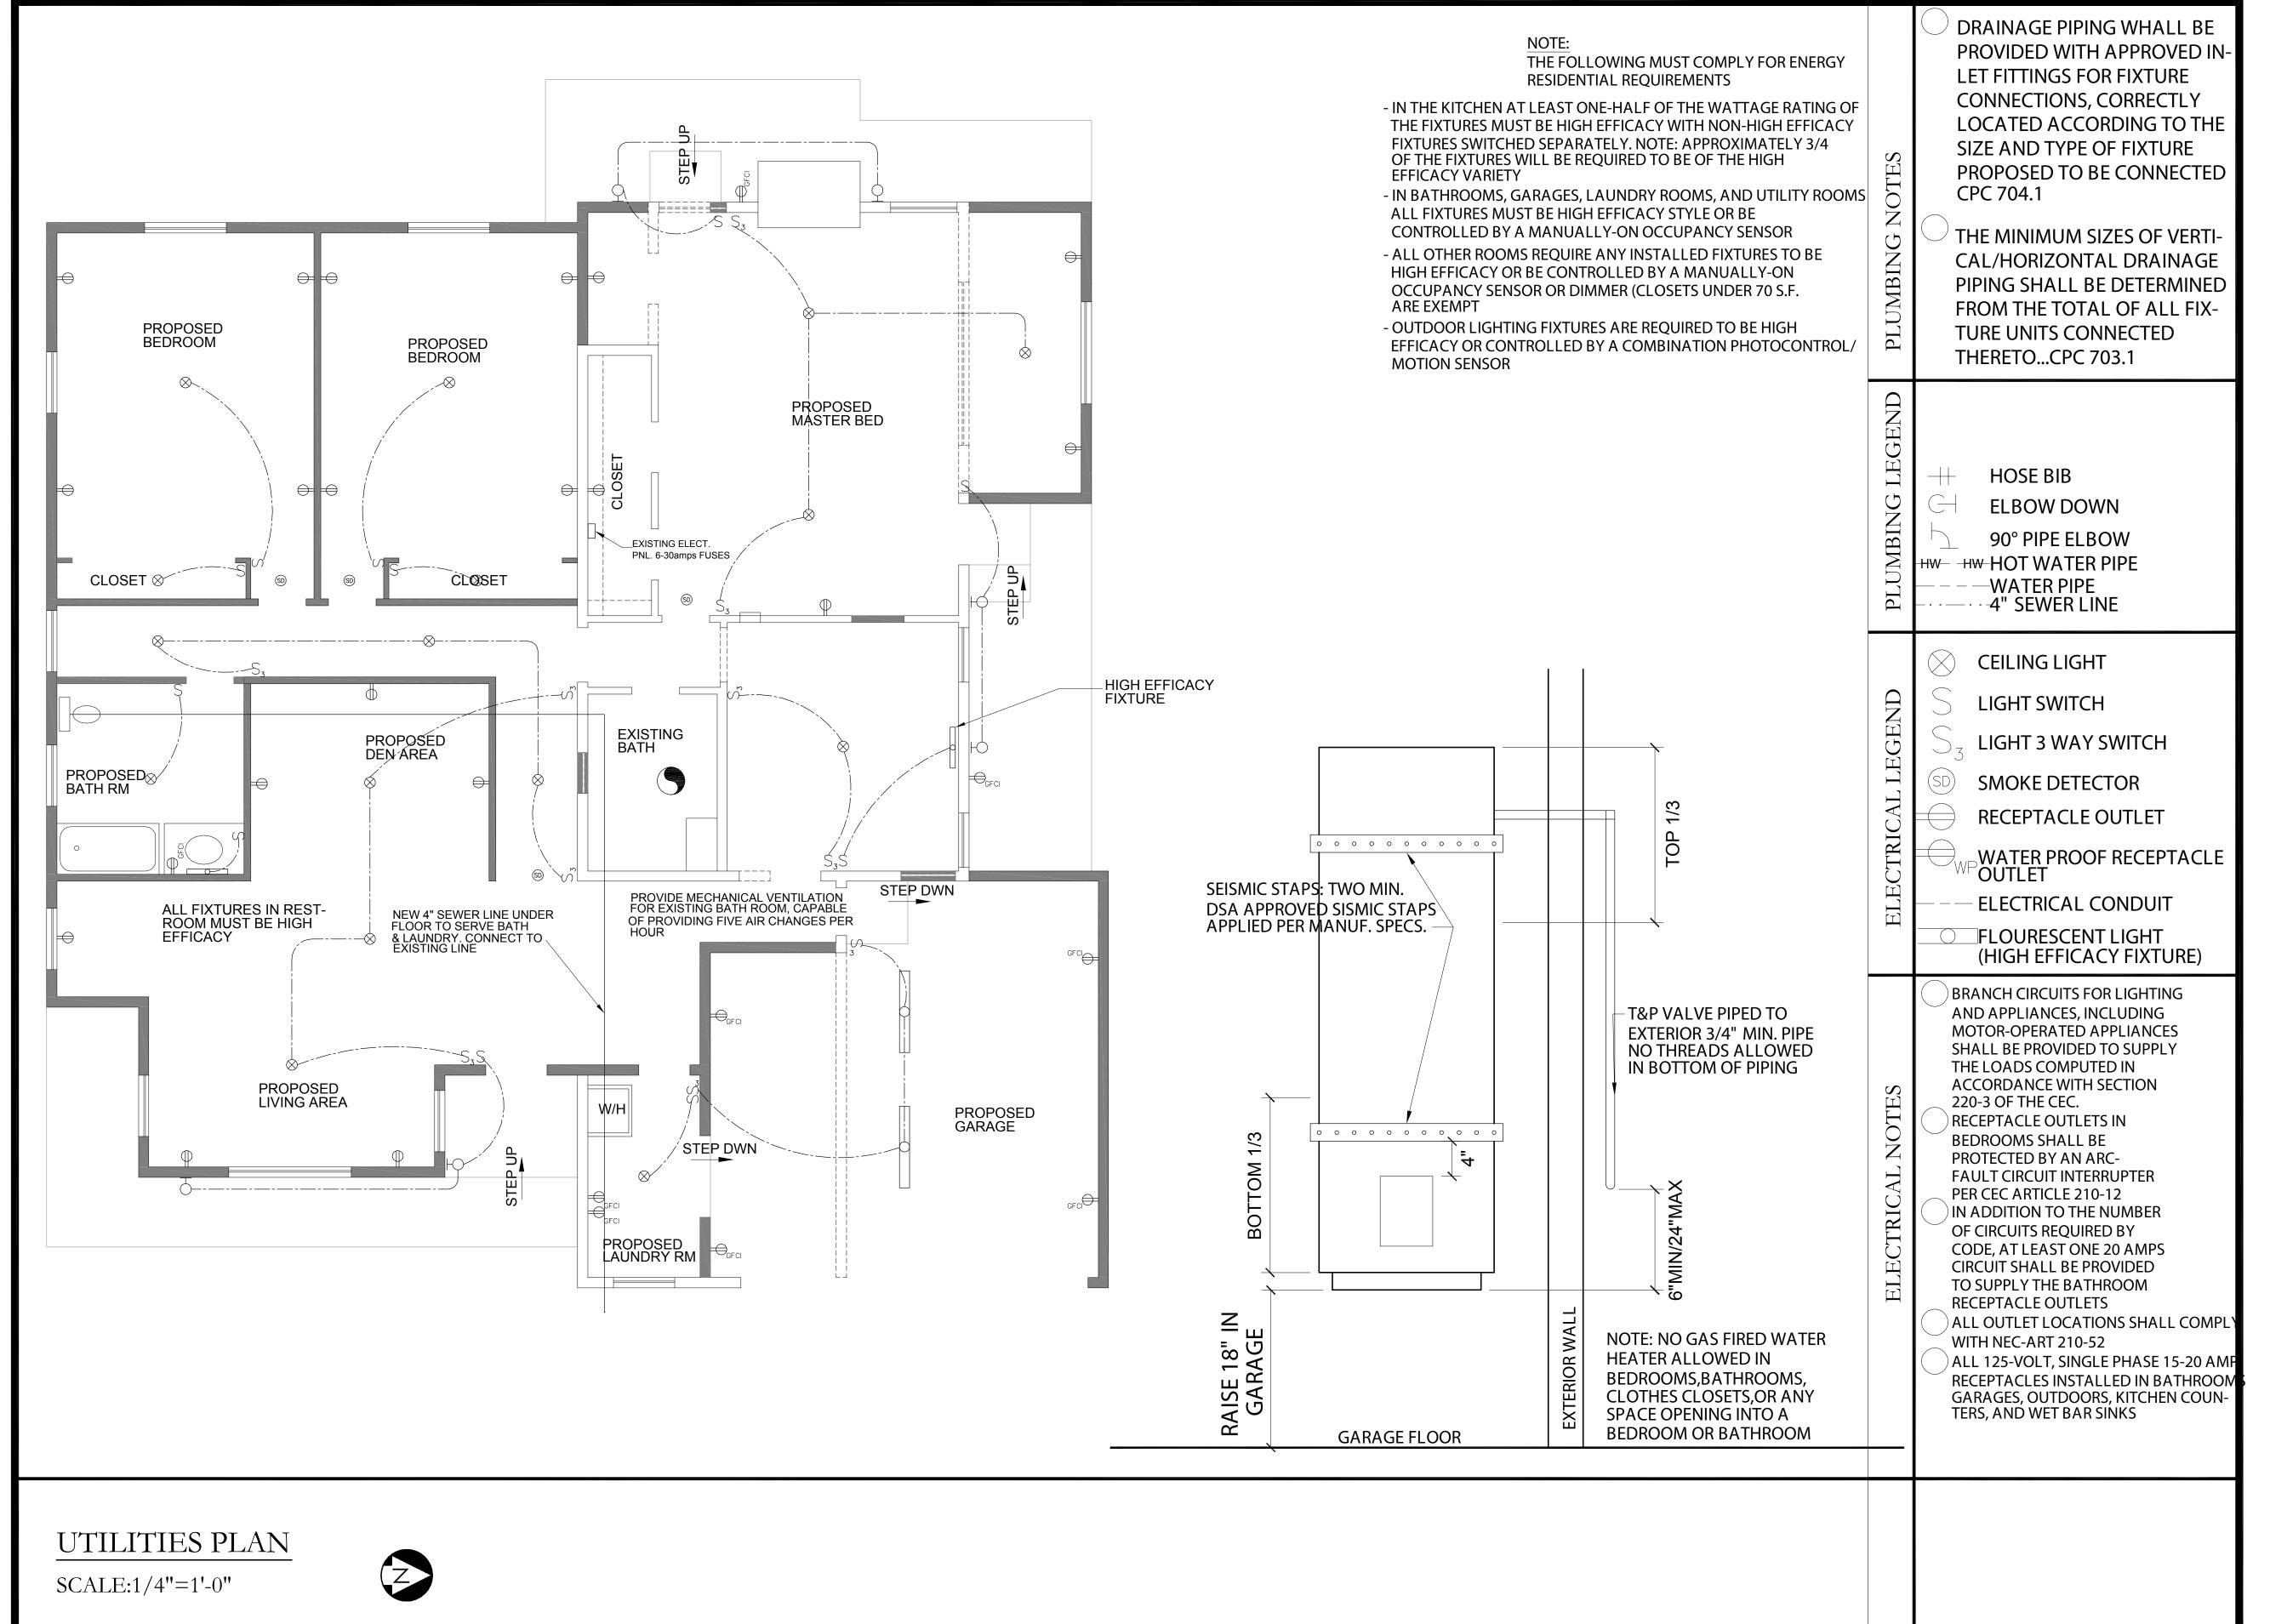


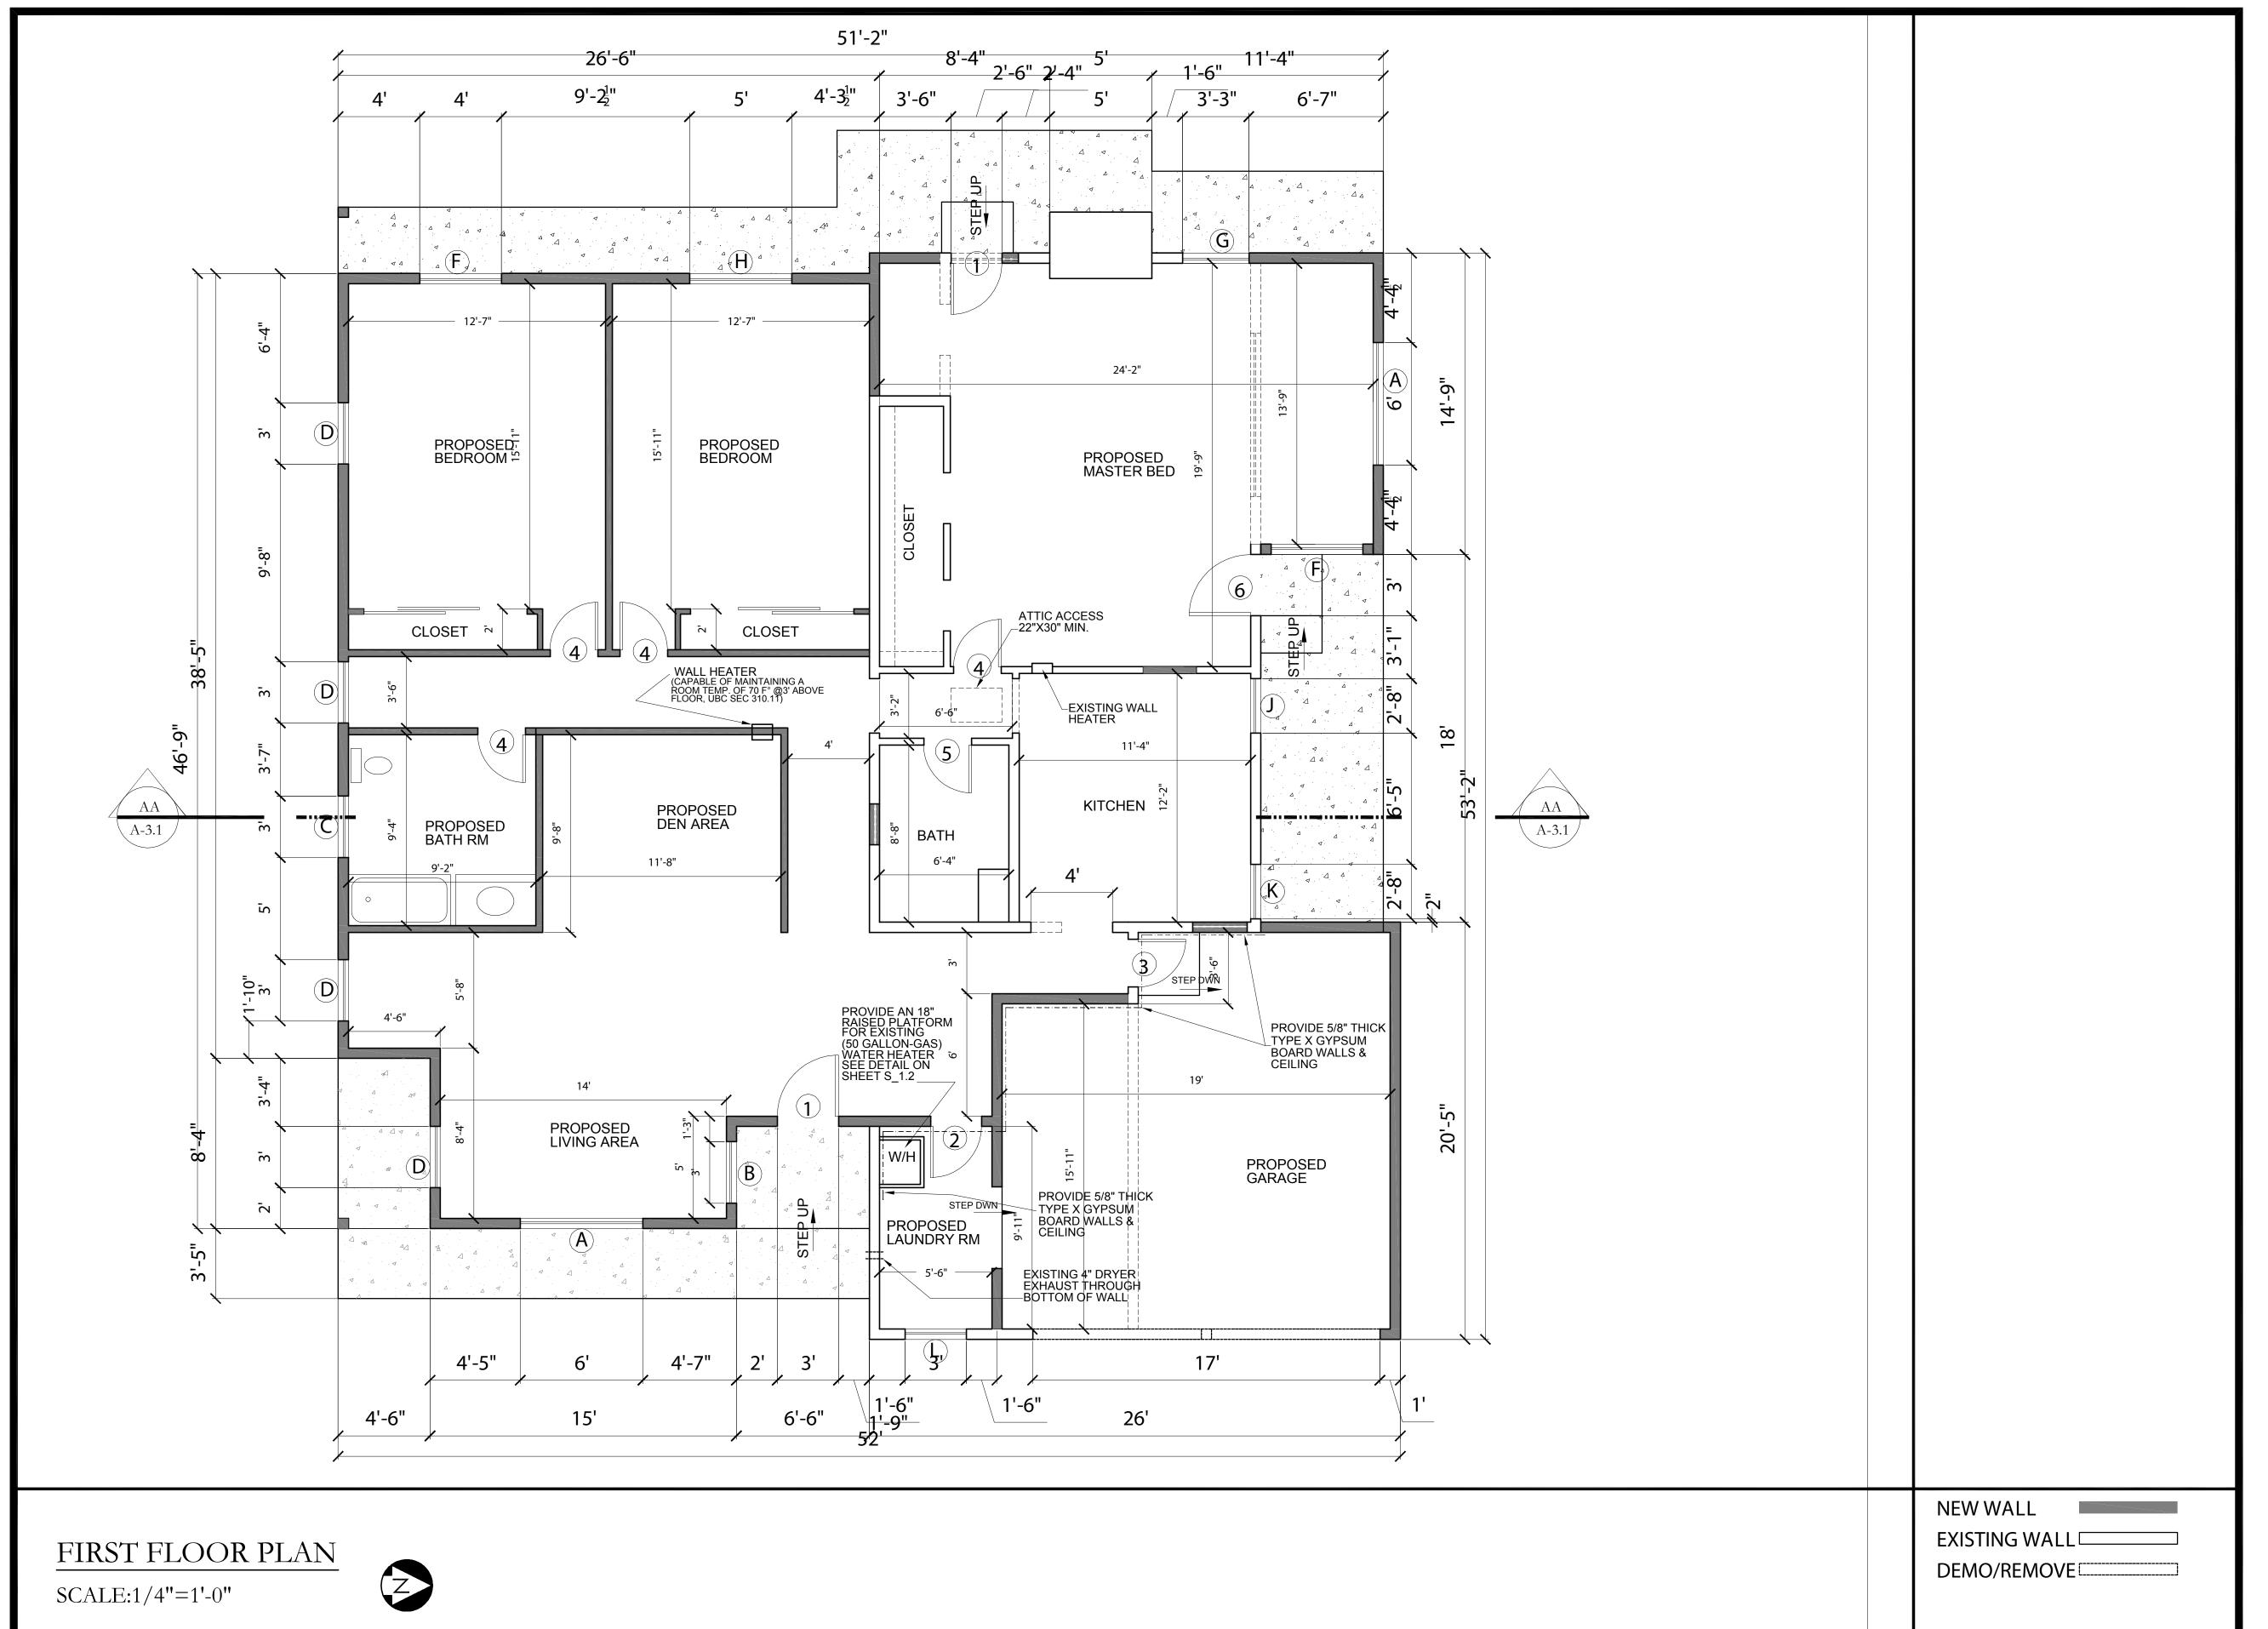
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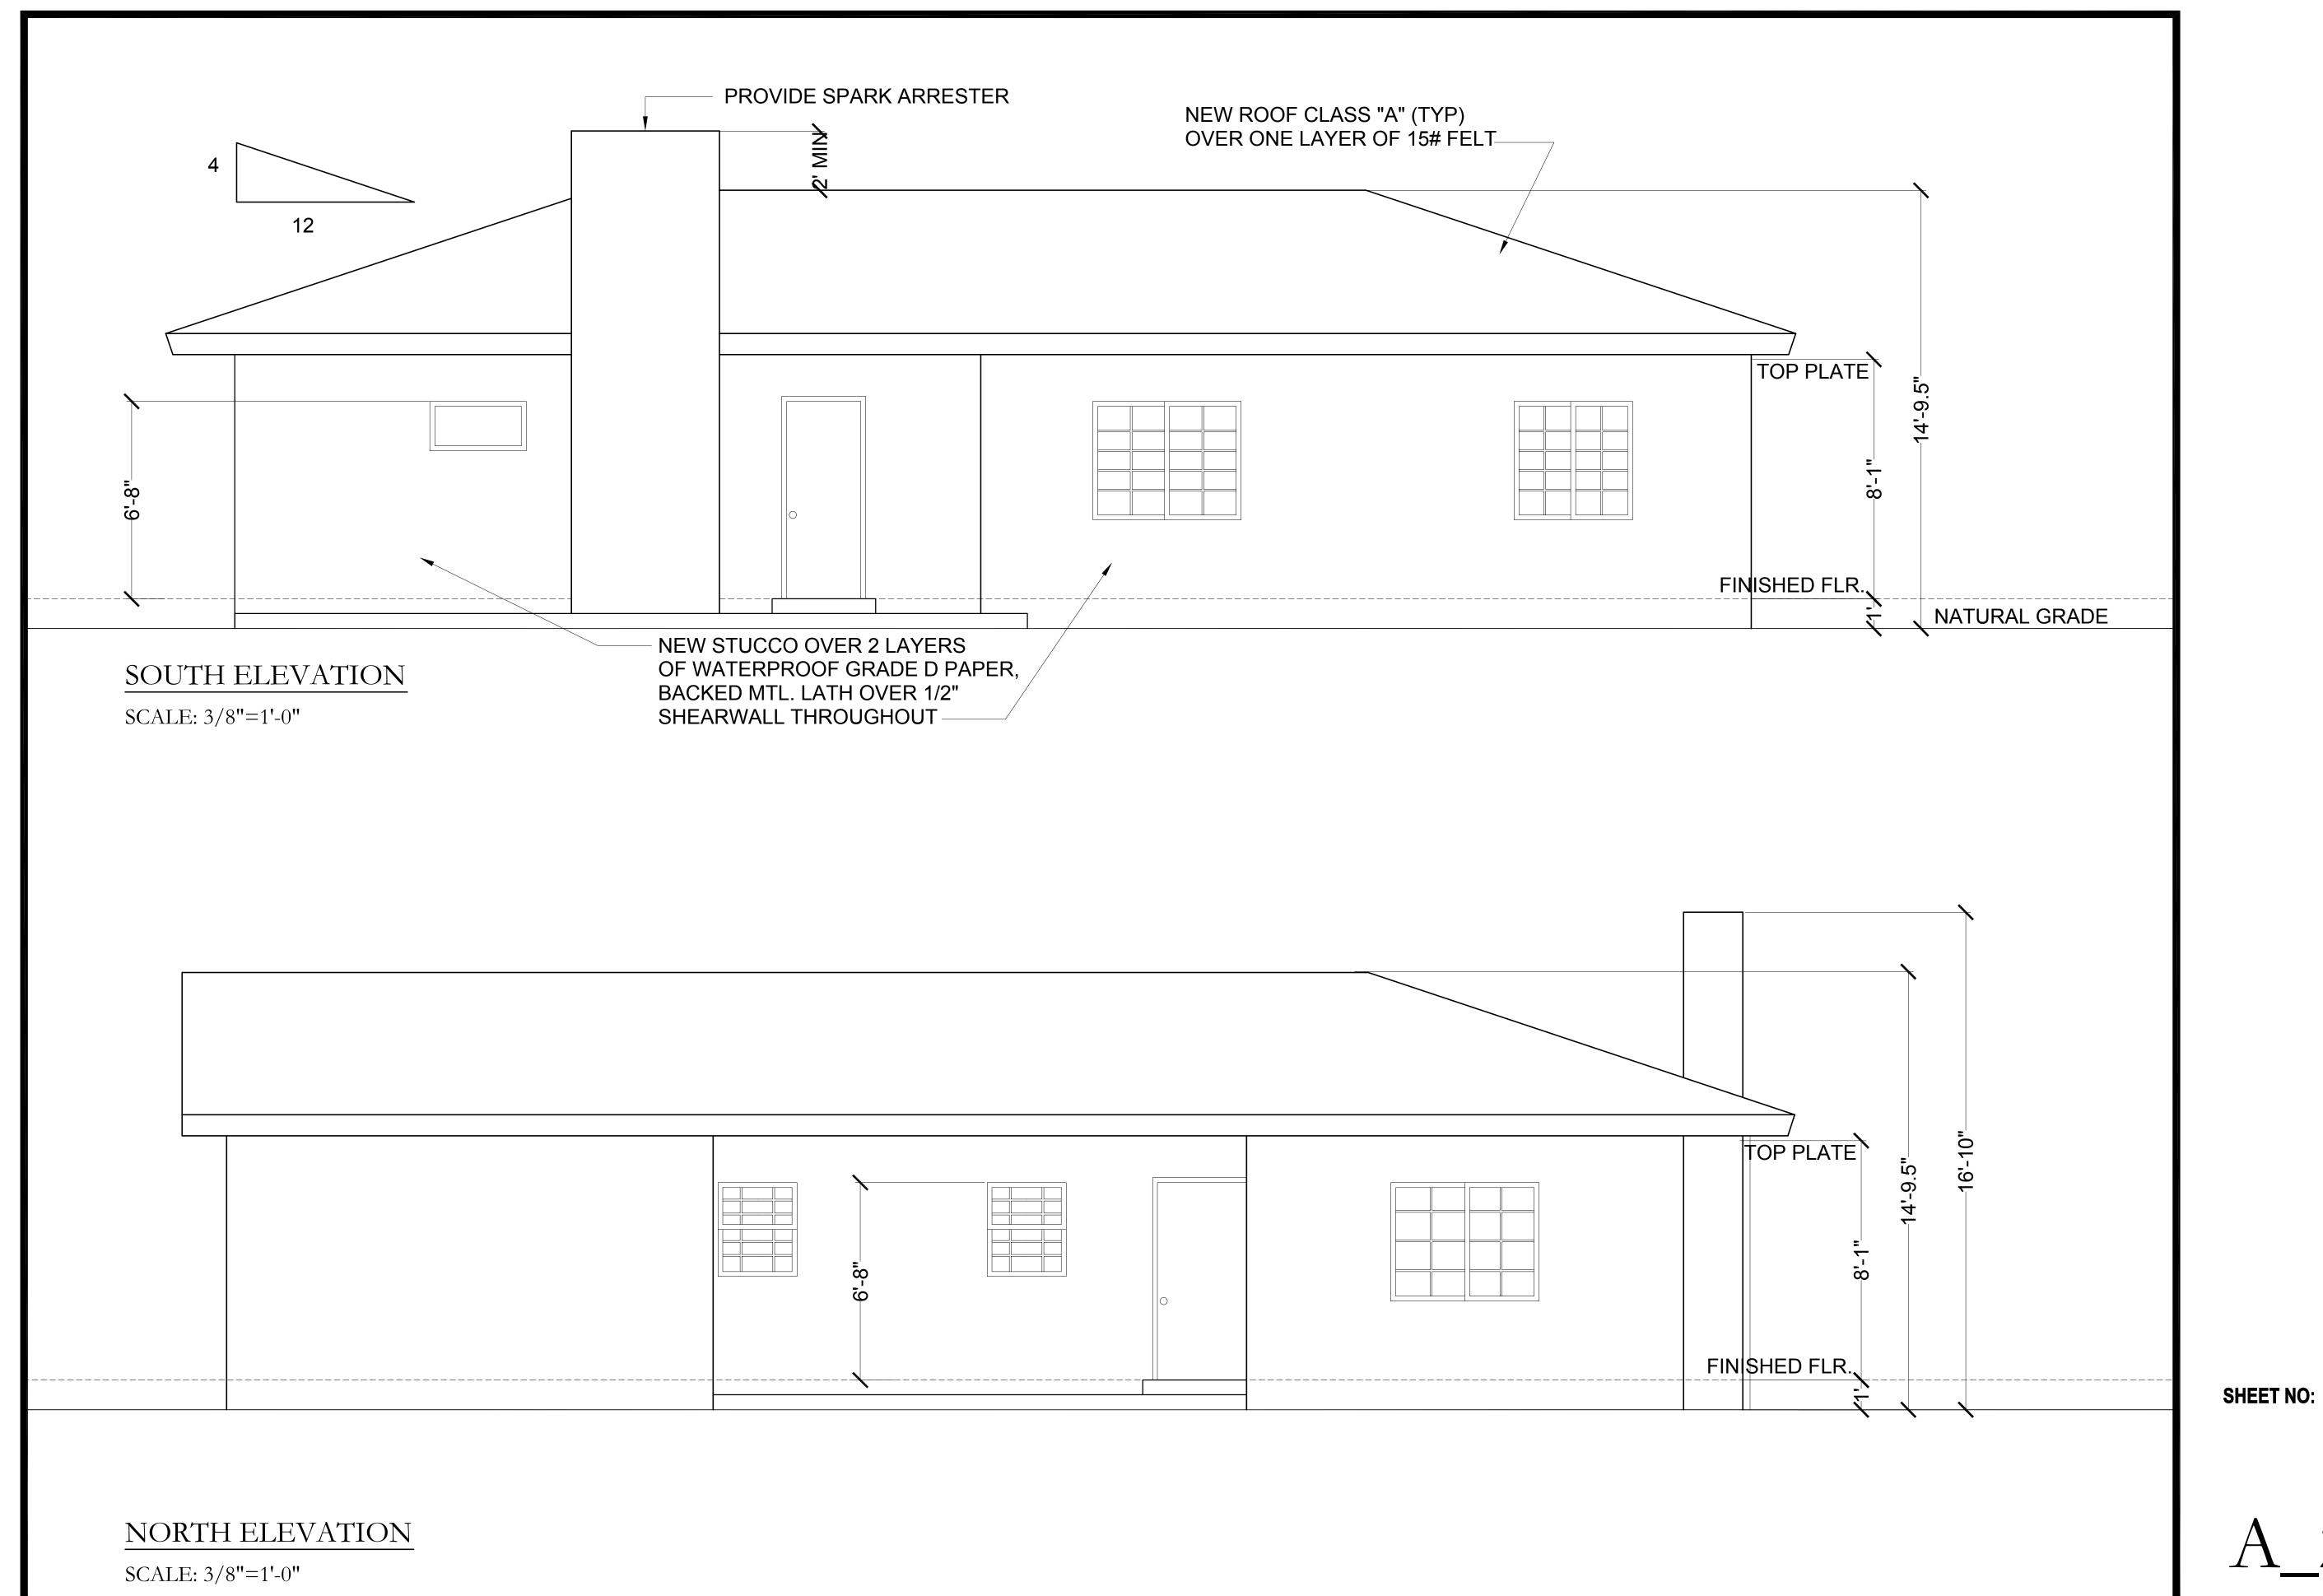



LOCATION

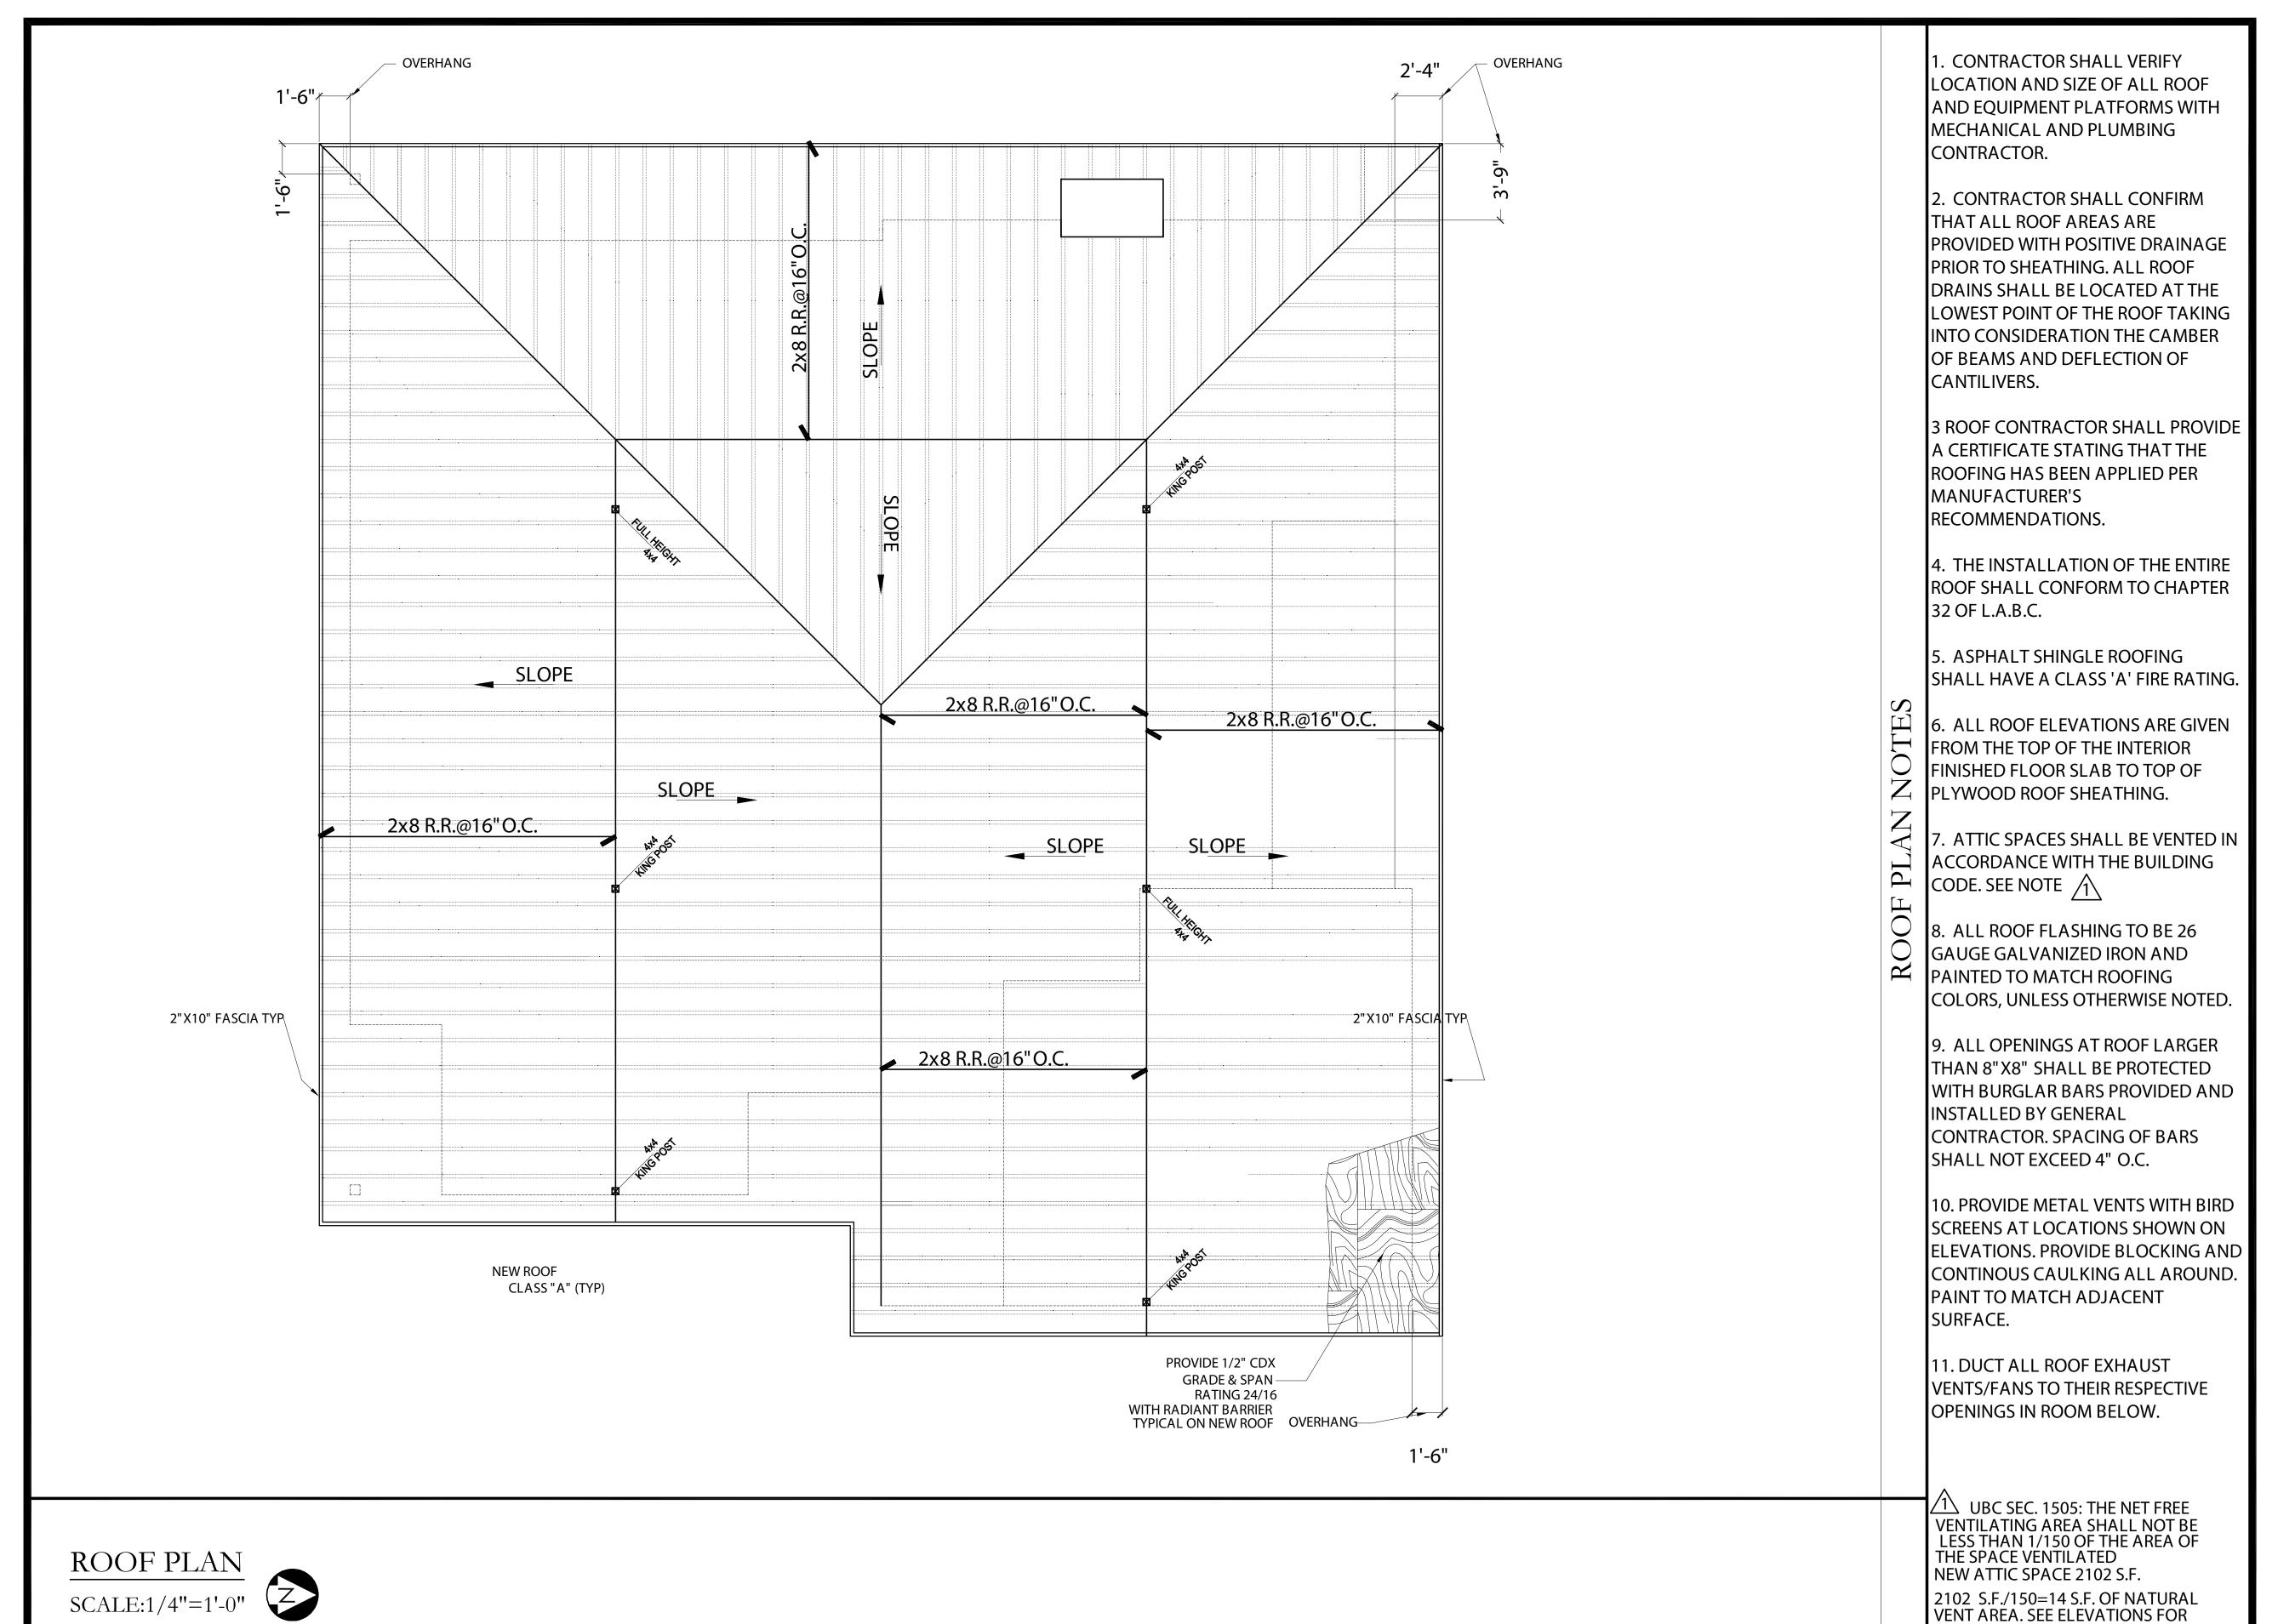A_1.3





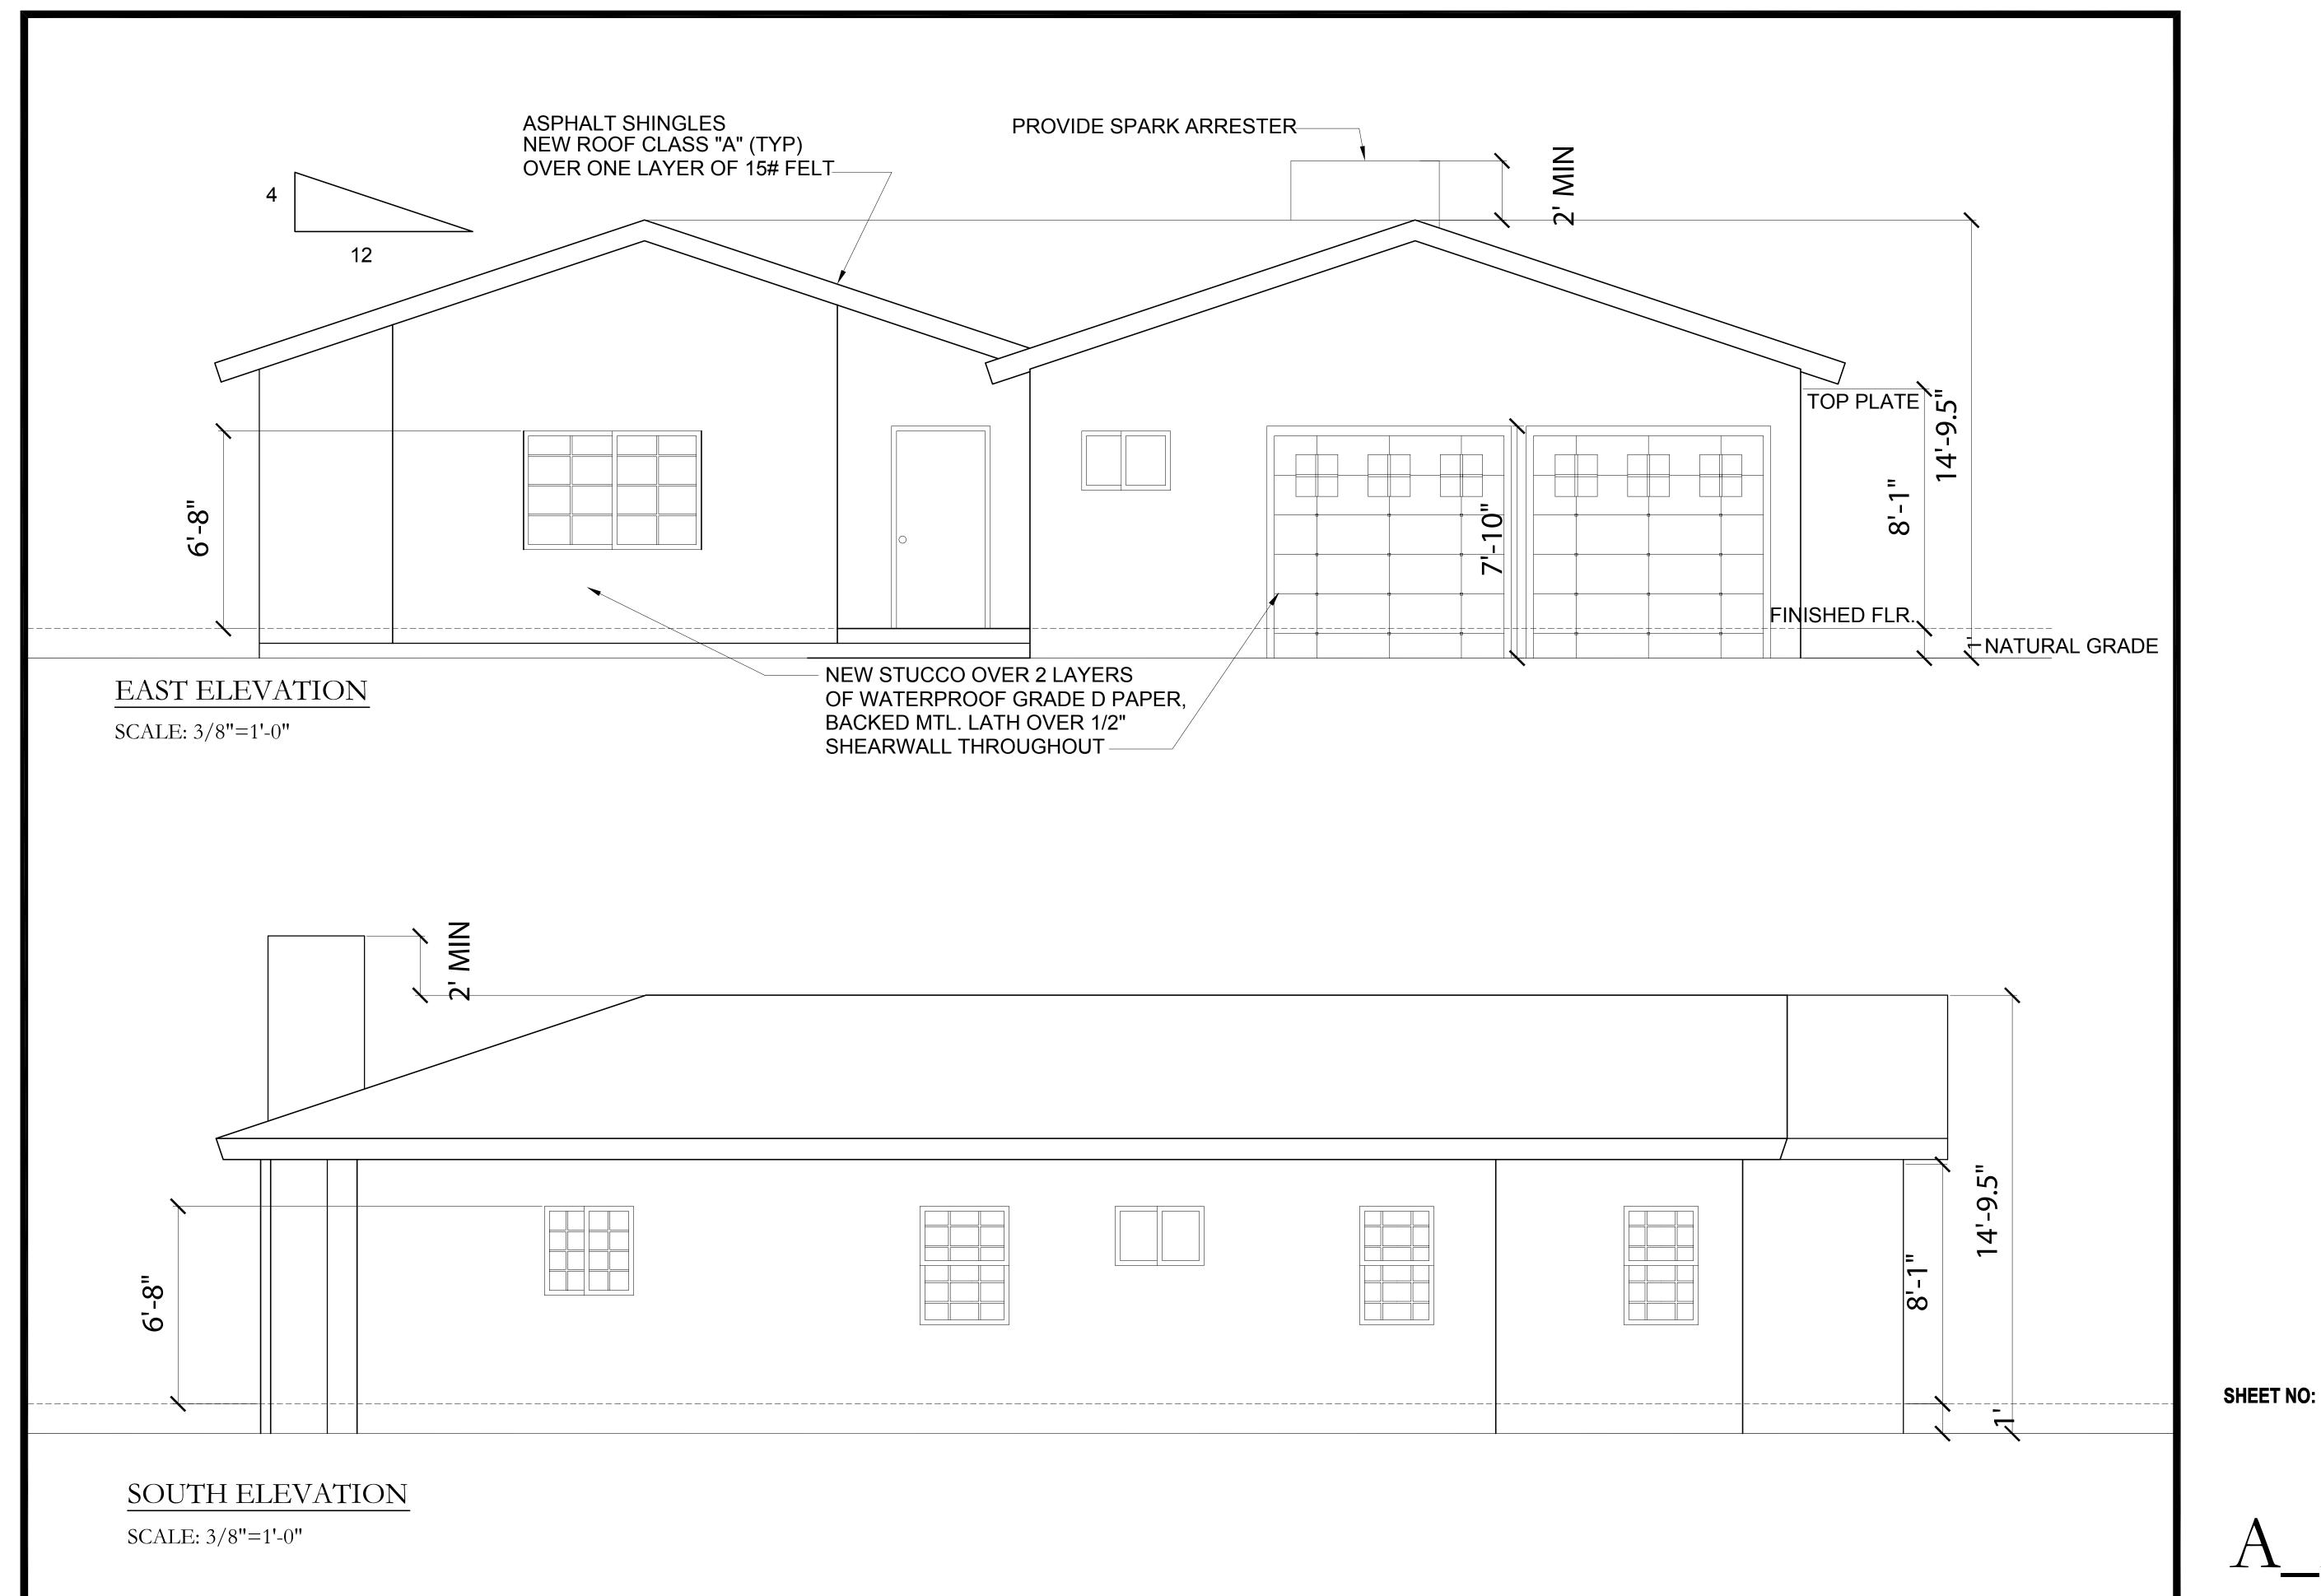

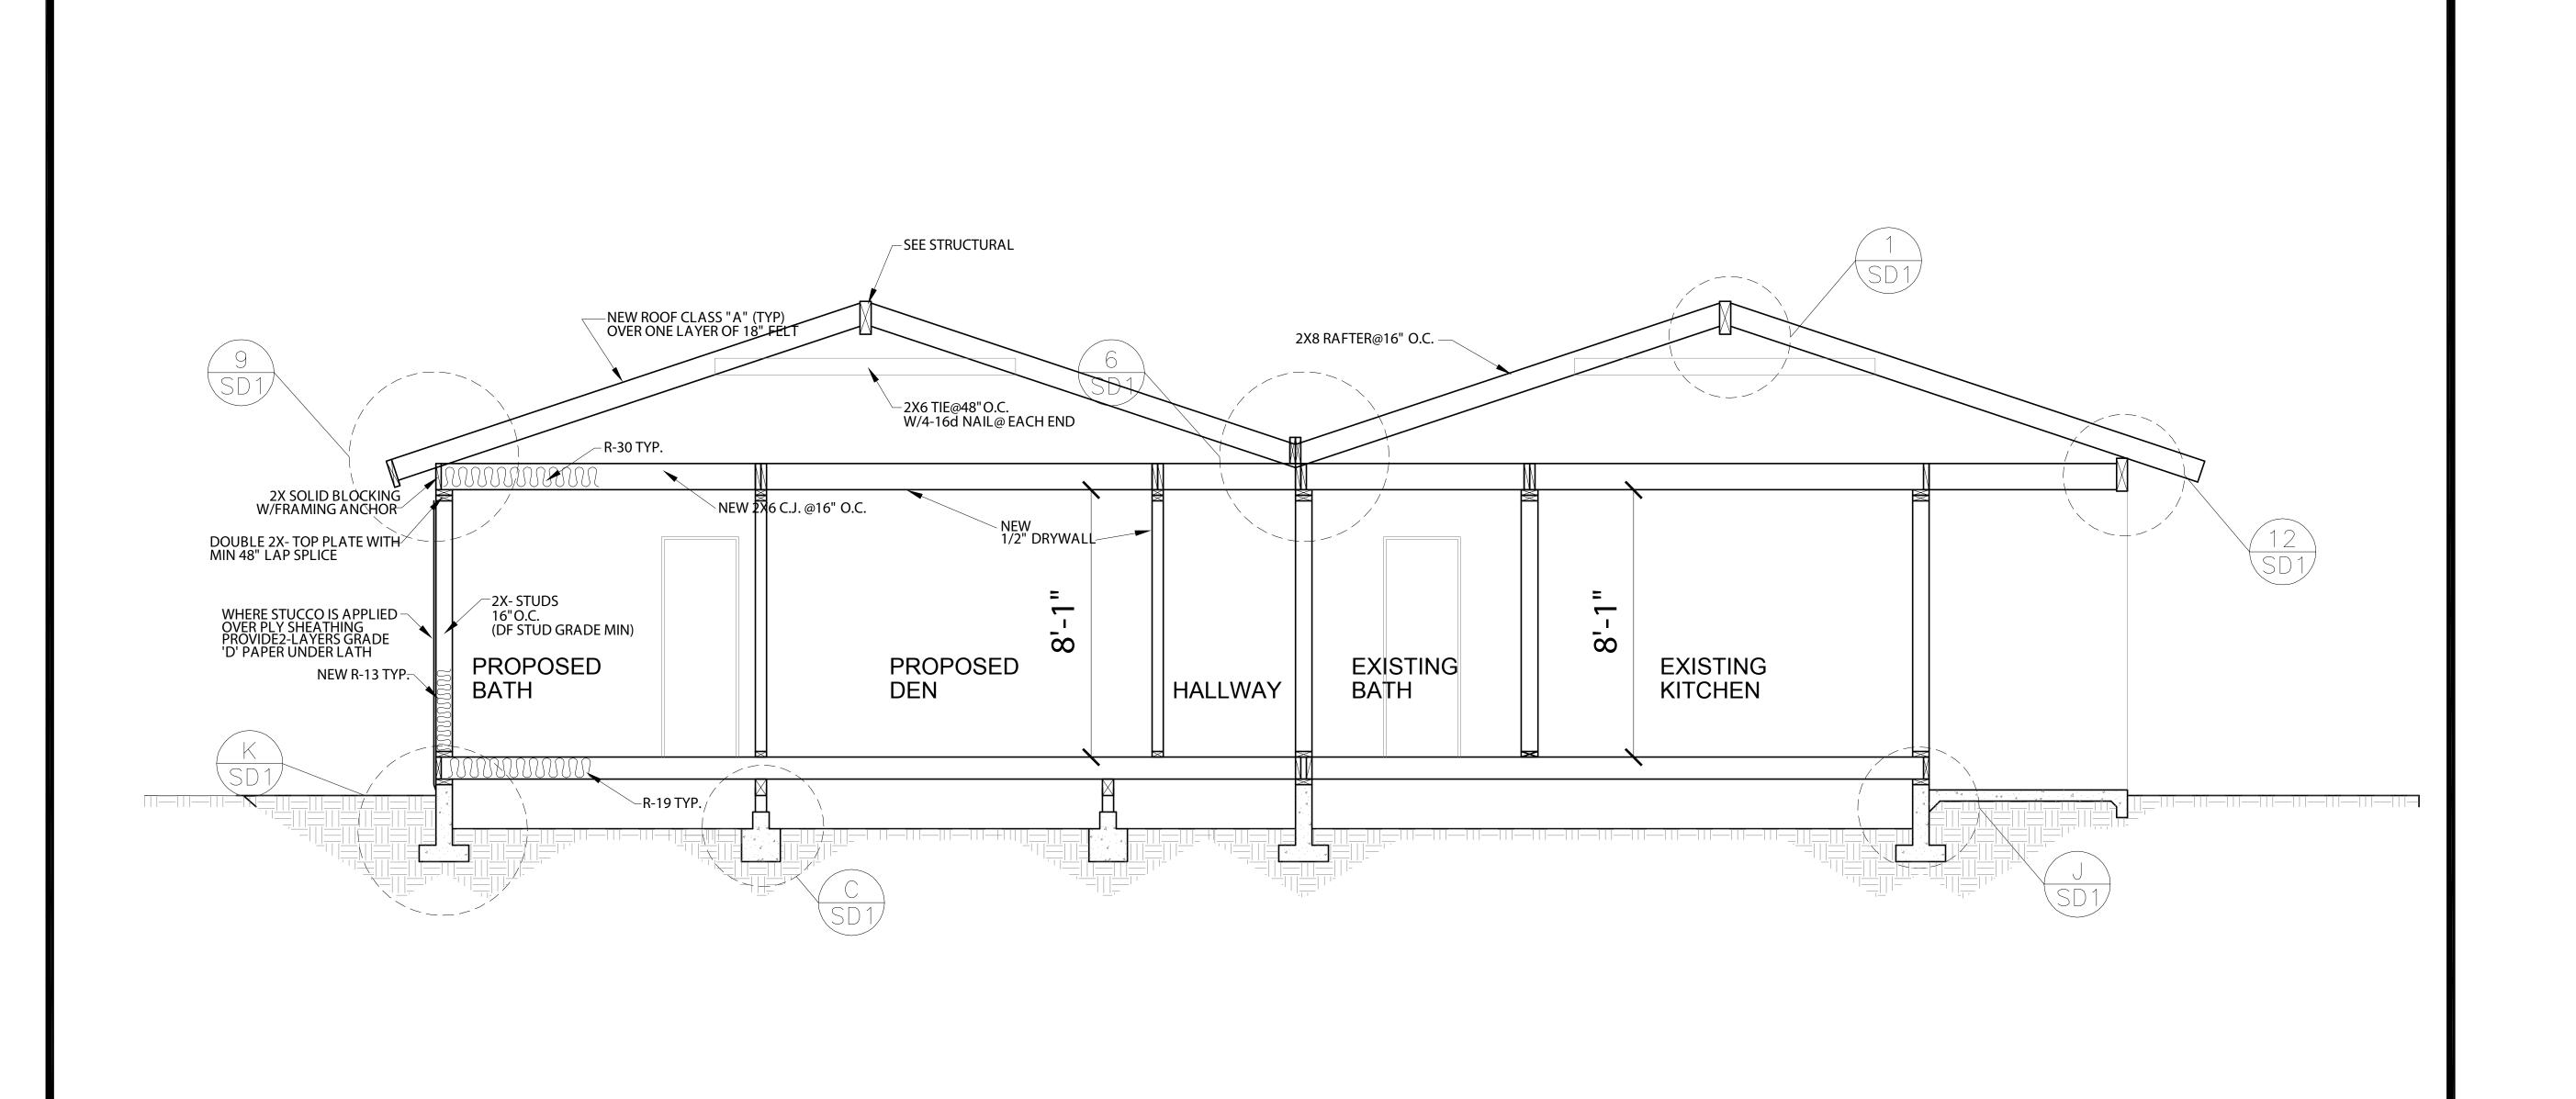

SECTION AA

SHEET NO:

SCALE: 3/8"=1'-0"
A 3.1