NEW GARAGE AND ACCESSORY DWELLING UNIT

436 E Covina Blvd. Covina, CA 91722

VICINITY MAP

2019 CALIFORNIA BUILDING CODE (CBC) 2019 CALIFORNIA RESIDENTIAL CODE (CRC) 2019 CALIFORNIA ADMINISTRATIVE CODE (CAC) 2019 CALIFORNIA MECHANICAL CODE (CMC) 2019 CALIFORNIA ELECTRICAL CODE (CEC) 2019 CALIFORNIA PLUMBING CODE (CPC) 2020 L.A. COUNTY FIRE CODE 2019 CALIFORNIA FIRE CODE (CFC) 2019 CALIFORNIA GREEN STANDARDS BUILDING CODE (CGBS) 2019 CALIFORNIA ENERGY EFFICIENCY CODE (CEEC) 2019 CALIFORNIA HISTORICAL BUILDING CODE (CHBS) CITY OF COVINA MUNICIPAL CODE

SHEET INDEX

APPLICABLE CODES:

COVER SHEET & EXISTING PLOT PLAN

EXISTING - AS BUILTS PROPOSED PLOT PLAN PROPOSED FLOOR PLANS

PROPOSED UTILITY PLANS STAIRS ENLARGE PLANS

PROPOSED ELEVATIONS PROPOSED ELEVATIONS

PROPOSED ROOF AND SECTION

DETAILS **DETAILS**

TITLE 24 COMPLIANCE TITLE 24 COMPLIANCE

STRUCTURAL NOTES

STRUCTURAL FRAMING AND **FOUNDATION PLANS**

SSW2 FRAMING DETAILS DRAINAGE PLAN NOTES

DRAINAGE PLAN

EROSION CONTROL PLAN

GENERAL NOTES:

THE OWNER/CONTRACTOR SHALL VERIFY ALL EXISTING CONDITIONS. DIMENSIONS AND ELEVATIONS BEFORE PROCEEDING WITH ANY **CONSTRUCTION WORK**

DO NOT SCALE DRAWINGS.

ALL DIMENSIONS ARE TO FACE STUDS, CONCRETE BLOCK, OR CENTER LINE OF STUDS.

ALL WORK, CONSTRUCTION, AND MATERIALS SHALL COMPLY WITH ALL PROVISION OF THE BUILDING CODE AND WITH OTHER RULES, COVERING THE PLACE OF THE BUILDING PROJECT. LOCAL BUILDING CODE REQUIREMENTS TAKE PRECEDENCE OVER THE DRAWINGS AND IT SHALL BE THE RESPONSIBILITY OF ANYONE SUPPLYING LABOR OR MATERIALS OR BOTH TO BRING TO THE ATTENTION OF THE OWNER OF ANY DISCREPANCIES OR CONFLICTS BETWEEN REQUIREMENTS OF THE CODE AND DRAWINGS REFERENCE TO ANY DETAILS OR DRAWING IS FOR CONVENIENCE ONLY

DISCREPANCIES IN THE DRAWINGS OR BETWEEN THE DRAWING AND ACTUAL FIELD CONDITIONS SHALL BE REPORTED TO THE OWNER CORRECTED DRAWINGS OR INSTRUCTIONS SHALL BE ISSUED BY THE

OWNER PRIOR TO THE INSTALLATION OF ANY WORK. THE OWNER IS RESPONSIBLE FOR ALL WORK SHOWN ON THESE DRAWINGS AND SPECIFICATIONS UNLESS SPECIFICALLY NOTED

OTHERWISE THE CONTRACT DRAWINGS AND SPECIFICATIONS REPRESENT THE FINISHED STRUCTURE UNLESS OTHERWISE SHOWN. THEY DO NOT INDICATE THE METHOD OF CONSTRUCTION. THE OWNER SHALL SUPERVISE AND DIRECT THE WORK AND HE/ SHE SHALL BE SOLELY RESPONSIBLE FOR ALL CONSTRUCTION MEANS, METHODS, TECHNIQUES, SEQUENCES, PROCEDURES, TO ACHIEVED THE FINISHED STRUCTURE.

AND DOES NOT LIMIT THE APPLICATION OF SUCH DETAIL OR DRAWING.

MAINTAIN SANITARY TOILET FACILITIES DURING CONSTRUCTION AS REQUIRED BY APPLICABLE REGULATIONS. IT SHALL BE THE RESPONSIBILITY OF THE CONTRACTOR FOR COORDINATING HIS WORK AND/OR EQUIPMENT SUPPLIED BY THE

CONTRACTOR. THE DESIGNER/DRAFTER WILL NOT BE RESPONSIBLE FOR ANY ACTION TAKEN BY ANYONE ON THE PROJECT IF THAT PERSON IS KNOWLEDGEABLE OF ANY DISCREPANCIES, OMISSIONS, OR AMBIGUITY IN THE DRAWINGS OR SPECIFICATIONS UNTIL THE DESIGNER/DRAFTER HAS BEEN NOTIFIED, HAS CORRECTED THE DISCREPANCY OR MORE CLEARLY EXPLAINED THE CONTENTS OF THE DRAWINGS OR

GLAZING MATERIALS AND INSTALLATION SHALL BE IN ACCORDANCE WITH SPECIFICATIONS

FIXED WINDOWS SHALL BE SEALED TO LIMIT AIR INFILTRATION. ALL DOORS SHALL LIMIT AIR LEAKAGE AROUND THEIR PERIMETER WHEN IN A CLOSE POSITION PROVIDE SEAL OR ASTRAGAL AT THE HEAD, SILL AND WALL JAMBS. OPEN EXTERIOR JOINTS AROUND WINDOW AND DOOR FRAMES, BETWEEN WALL AND ROOF, BETWEEN PANELS AND AT PENETRATIONS OF UTILITIES THRU ENVELOPE SHALL BE SEALED, CAULK


OR WEATHER STRIPPED TO LIMIT AIR LEAKAGE. IF REQUIRED BY THE BUILDING INSPECTOR, A PROTECTION FENCE SHALL BE CONSTRUCTED AND MAINTAINED CONFORMING TO THE REQUIREMENTS OF THE THE BUILDING CODE.

CONTINUOUS INSPECTION BY A DEPUTY INSPECTOR IS REQUIRED FOR ALL CONCRETE DESIGNED W/ F'C GREATER THAN 2500 PSI. AT GRADE


CONTINUOUS INSPECTION BY A DEPUTY INSPECTOR REQUIRED FOR HIGH STRENGTH BOLTS.

ALL INTERIOR FLOORING. COLORS, AND ALL OTHER DECORATIVE

MATERIAL TO BE DETERMINED BY OWNER. ALL WORK IN THE PUBLIC RIGHT OF WAY SHALL BE DONE PER CITY STANDARDS.

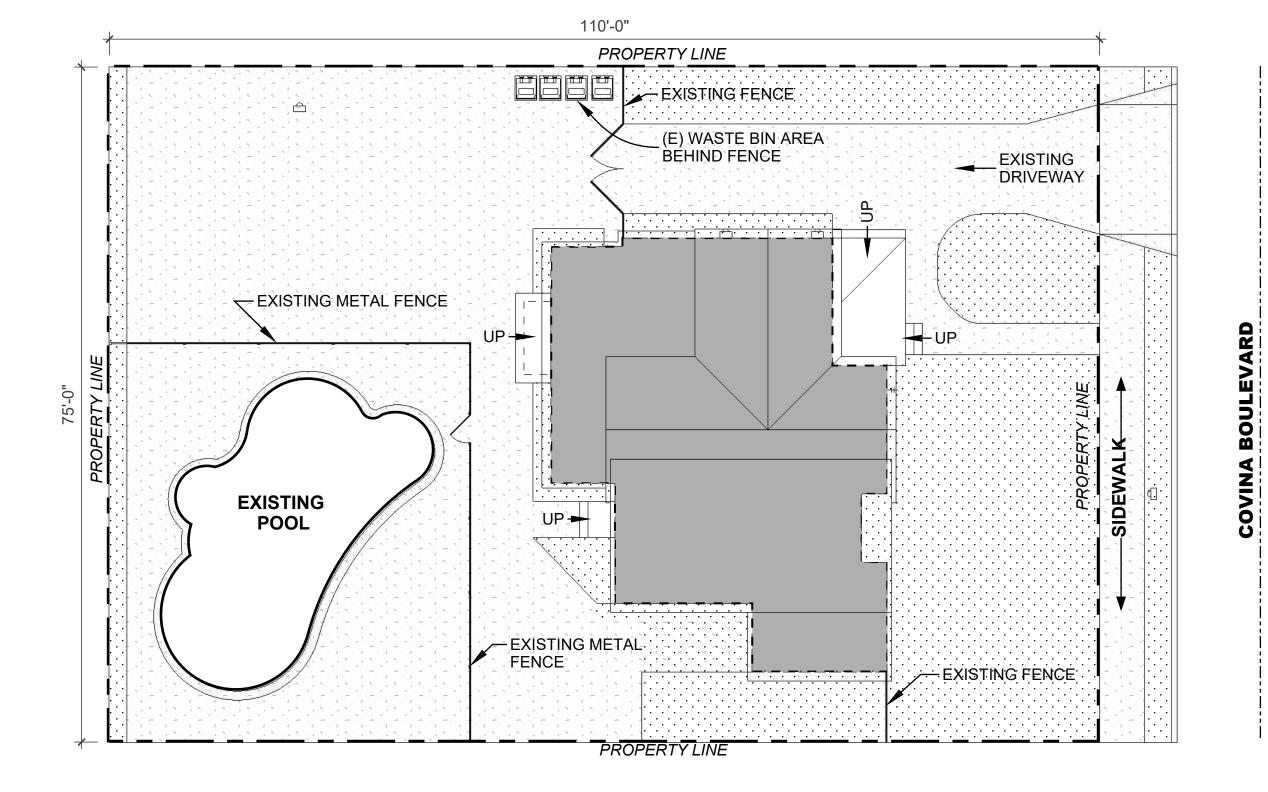

EXISTING PLOT PLAN 3/32" = 1'-0"

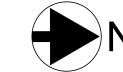

DESTRUCTIVE REMOVAL OF WORK PERFORMED WITHOUT PERMITS MAY BE REQUIRED FOR INSPECTION(S)

DEPUTY INSPECTORS ARE REQUIRED TO BE REGISTERED WITH THE CITY

EACH CONTRACTOR RESPONSIBLE FOR THE CONSTRUCTION OF A MAIN WIND. OR SEISMIC FORCE-RESISTING COMPONENT LISTED IN THE STATEMENT OF SPECIAL INSPECTIONS SHALL SUBMIT A WRITTEN STATEMENT OF RESPONSIBILITY TO THE BUILDING OFFICAL AND THE OWNER OR THE OWNER'S AUTHORIZED AGENT PRIOR TO THE COMMENCEMENT OF WORK ON THE SYSTEM OR COMPONENT. THE CONTRACTOR'S STATEMENTOR RESPONSIBILITY SHALL CONTAIN ACKNOWLEDGEMENT OF AWARNESS OF THE SPECIAL REQUIREMENTS CONTAINED IN THE STATEMENT OF SPECIAL INSPECTION (2016 BC 1704.4)

SEDIMENT CONTROL

FOR LOTS UNDER ONE ACRE; IF THE CONTRUCTION TAKES PLACE DURING THE RAINY SEASON BETWEEN NOVEMBER 30 AND APRIL 15, INSTALL A PERIMETER SEDIMENT CONTROL MEASURE SUCH AS A LAYER OF GRAVEL BAGS, FIBER ROLLS OR FILTER LOGS AROUND THE DOWNHILL BOUNDARIES (LOT LINES) OF SITE, UNLESS THE DRAINAGE FLOWS TOWARDS A BLOCK WALL ON THE PROPERTY LINE.

THE DISCHARGE OF POLLUTANTS TO ANY STORM DRAINAGE SYSTEM IS PROHIBITED. NO SOLID WASTE, PETROLEUM BYPRODUCTS, SOIL PARTICULATE. CONSTRUCTION WASTE MATERIALS, OR WASTEWATER GENERATED ON CONSTRUCTION SITES OR BY CONSTRUCTION ACTIVITIES SHALL BE PLACED, CONVEYED OR DISCHARGED INTO THE STREET, GUTTER OR STORM DRAIN

/---**GREEN BUILDING STANDARDS NOTES:**

- ANNULAR SPACES AROUND PIPES, ELECTRIC CABLES, CONDUITS, OR OTHER OPENINGS IN PLATES AT EXTERIOR WALLS SHALL BE PROTECTED AGAINST THE PASSAGE OF RODENTS BY CLOSING SUCH OPENINGS WITH CEMENT MORTAR, CONCRETE MASONRY OR SIMILAR METHOD. CGBS 4.406.1
- DUCT OPENINGS AND OTHER RELATED AIR DISTRIBUTION COMPONENTS OPENING SHALL BE COVERED DURING CONTRUCTION. CGBS 4.504.1 ADHESIVES, SEALANTS AND CAULKS SHALL BE COMPLIANT WITH VOC AND OTHER TOXIC COMPOUND LIMITS PER CGBS 4.504.2.1

a. PAINT, STAINS AND OTHER COATINGS SHALL BE COMPLIANT WITH VOC LIMITS b. AEROSOL PAINTS AND COATINGS SHALL BE COMPLIANT WITH PRODUCT WEIGHTED MIR LIMITS FOR ROC AND OTHER TOXIC COMPOUNDS.

c. DOCUMENTATION SHALL BE PROVIDED TO VERIFY COMPLIANT VOC LIMIT

FINISH MATERIALS HAVE BEEN USED. d. CARPET AND CARPET SYSTEMS SHALL BE COMPLIANT WITH VOC LIMITS. e. 50% OF THE FLOOR AREA RECEIVING RESILIENT FLOORINGS SHALL COMPLY WITH THE VOC EMISSION LIMITS DEFINED IN THE COLLABORATIVE FOR HIGH PERFORMANCE SCHOOLS (CHPS) LOW-EMITTING MATERIALS LIST OR BE

CERTIFIED UNDER THE RESILIENT FLOOR COVERING INSTITUTE (RFCI) FLOORSCORE PROGRAM. f. PARTICLEBOARD, MEDIUM DENSITY FIBERBOARD (MDF) AND HARDWOOD

PLYWOOD USED IN INTERIOR FINISH SYSTEMS SHALL COMPLY WITH LOW FORMALDEHYDE EMISSIONS STANDARDS.

FOLLOW TABLES FOR POLLUTION CONTROL LIMITS PER SECTION CGBS 4.504 (TABLES REFERENCE ON A4.1 SHEET) a. 4.504.4.1 ADHESIVE VOC LIMIT b. 4.504.4.2 SEALANT VOC LIMIT

c. 4.504.4.3 VOC CONTENT LIMITS FOR ARCHITECTURAL COATINGS CONCRETE SLABS, PROVIDE A VAPOR RETARDER (MIN. 6-MIL THICKNESS) WITH CAPILLARY BREAK CONSISTING OF 4" OF 1/2" OR LARGER CLEAN AGGREGATE TO BE INSTALL AT THE SLAB ON GRADE FOUNDATIONS. CGBS 4.505.2.1

STRUCTURAL NOTES:

\----THE PROJECT WILL REQUIRE STRUCTURAL OBSERVATION BY THE ENGINEER RESPONSIBLE FOR THE STRUCTURAL DESIGN. STRUCTURAL OBSERVATION MEANS THE VISUAL OBSERVATION OF THE STRUCTURAL SYSTEM, FOR GENERAL CONFORMANCE WITH THE APPROVED PLAN AND AND SPECIFICATIONS AT SIGNIFICAN CONSTRUCTION STAGES AND AT COMPLETION OF THE STRUCTURAL SYSTEM.

ROOF NOTES:

- CONTRACTOR SHALL VERIFY LOCATION AND SIZE OF ALL ROOF AND EQUIPMENT PLATFORMS WITH MECHANICAL AND PLUMBING CONTRACTOR.
- CONTRACTOR SHALL CONFIRM THAT ALL ROOF AREAS ARE PROVIDED WITH POSITIVE DRAINAGE PRIOR TO SHEATHING. ALL ROOF DRAINS SHALL BE LOCATED AT THE LOWEST POINT OF THE ROOF TAKING INTO CONSIDERATION THE CAMBER OF BEAMS AND DEFLECTION OF
- ROOF CONTRACTOR SHALL PROVIDE A CERTIFICATE STATING THAT THE ROOFING HAS BEEN APPLIED PER MANUFACTURER'S **RECOMMENDATIONS**
- THE INSTALLATION OF THE ENTIRE ROOF SHALL CONFORM TO CHAPTER 32 OF L.A.B.C.
- LIGHT WEIGHT TILE ROOFING SHALL HAVE A CLASS 'A' FIRE RATING. ALL ROOF ELEVATIONS ARE GIVEN FROM THE TOP OF THE INTERIOR FINISHED FLOOR SLAB TO TOP OF PLYWOOD ROOF SHEATHING. ATTIC SPACES SHALL BE VENTED IN ACCORDANCE WITH THE BUILDING
- CODE. (SEE ELEVATIONS NOTES) ALL ROOF FLASHING TO BE 26 GAUGE GALVANIZED IRON AND PAINTED TO MATCH ROOFING COLORS, UNLESS OTHERWISE NOTED.
- ALL OPENINGS AT ROOF LARGER THAN 8"X8" SHALL BE PROTECTED WITH BURGLAR BARS PROVIDED AND INSTALLED BY GENERAL CONTRACTOR. SPACING OF BARS SHALL NOT EXCEED 4" O.C.
- PROVIDE METAL VENTS WITH BIRD SCREENS AT LOCATIONS SHOWN ON ELEVATIONS. PROVIDE BLOCKING AND CONTINUOUS CAULKING ALL AROUND. PAINT TO MATCH ADJACENT SURFACE. (SEE ELEVATIONS) DUCT ALL ROOF EXHAUST VENTS/FANS TO THEIR RESPECTIVE OPENINGS
- A MINIMUM OF 1" OF AIRSPACE SHALL BE PROVIDED BETWEEN THE INSULATION AND THE ROOF SHEA THING AT THE VENT LOCATION, PER I

- COUNTY CONTRACTOR CITY OF COVINA **CORRECTIONS: 11/30/2021** ・~・~・~・~・

COVER SHEET

PROJECT NUMBER DRAWN BY

CODE ANALYSIS

SCOPE OF WORK: CONSTRUCTION OF A NEW 500 SF DETACHED TWO CAR GARAGE WITH A 520 SF ACCESSORY DWELLING <u>UNIT ABOVE</u>

OCCUPANCY AND CONSTRUCTION: TYPE OF CONSTRUCTION - **VB** OCCUPANCY: R3

ALLOWABLE AREA AND HEIGHT: EXISTING BUILDING HEIGHT = NO CHANGE

EXISTING BUILDING AREA = 2430 SF (TWO STORIES) NO CHANGE TO EXISTING RESIDENCE PROPOSED DETACHED ADDITION = 1020 SF **GROUND FLOOR GARAGE: 500 SF**

EXISTING LOT COVERAGE: 1420 SF/8250 SF= 17.5% LOT COVERAGE PROPOSED LOT COVERAGE: EXISTING RESIDENCE 1420 SF PROPOSED (GARAGE)

1920 SF/8250 SF = 24% LOT COVERAGE

NOTES: NO EXISTING COVERED PARKING

DEFERED SUBMITALS

DEFERRED SUBMITAL ITEMS WILL BE REQUIRED TO BE SUBMITTED, APPROVED AND PERMITTED PRIOR TO THE FRAMING INSPECTION. LIFE SAFETY ITEMS ARE NOT APPROVED FOR DEFERRED SUBMITTAL


DEFERRED SUBMITAL ITEMS: -REQUIRED PV SYSTEM APPROVAL

-SOILS REPORT AND GRADING PLANS - PERMIT APPROVAL


SECOND FLOOR ADU: 520 SF OVERALL LOT AREA = 8250 SF

TOTAL 1920 SF

NO FIRE SPRINKLERS REQUIRED

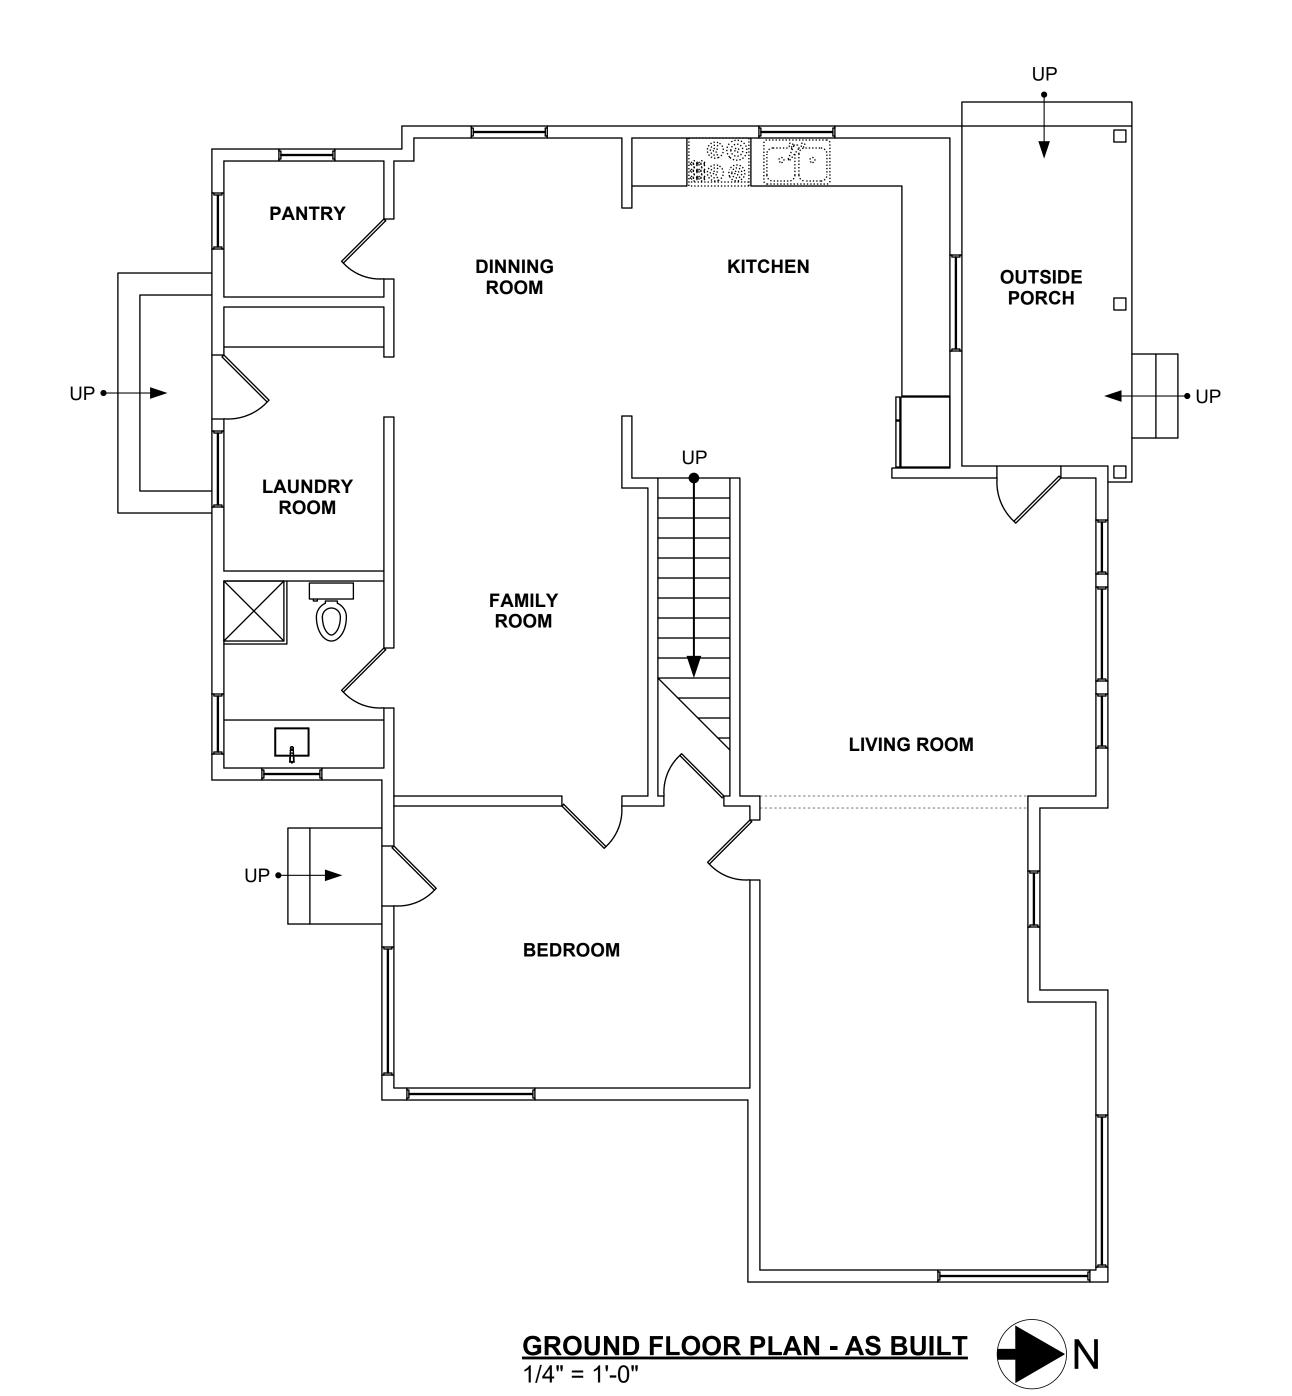



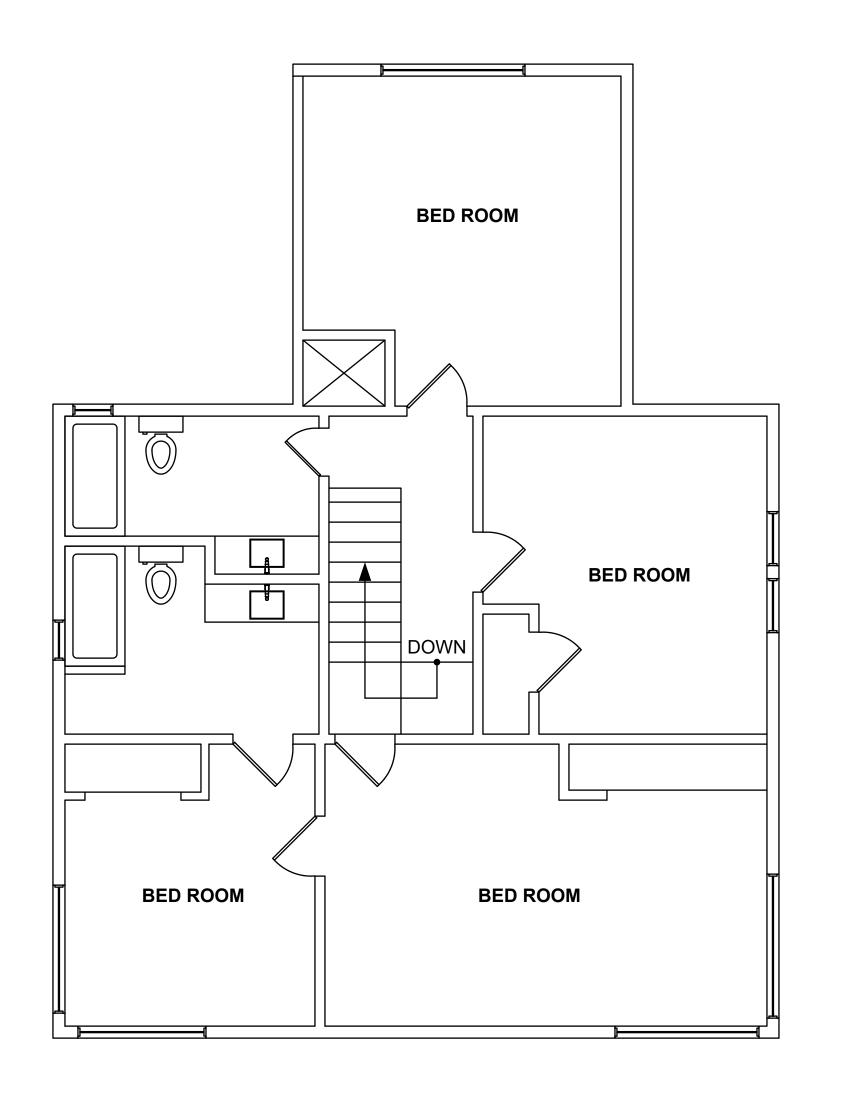





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NOTES:

EXISTING BUILDING FOOTPRINT = 1420 SQ FT. NO CHANGE TO EXISTING RESIDENCE OVERALL LOT AREA = 8250 SF (110' X 75')

EXISTING LOT COVERAGE: 1420 SF/8250 SF= 17.5% LOT COVERAGE

PROPOSED LOT COVERAGE:

EXISTING FOOTPRINT 1420 SF
PROPOSED FOOTPRINT 500 SF
TOTAL FOOTPRINT 1920 SF

1920 SF/8250 SF = 24% LOT COVERAGE

SITE PLAN NOTES:

1. THE DISCHARGE OF POLLUTANTS TO ANY STORM DRAINAGE SYSTEM IS PROHIBITED. NO SOLID WASTE, PETROLEUM BYPRODUCTS, SOIL PARTICULATE, CONSTRUCTION WASTE MATERIALS, OR WASTEWATER GENERATED ON CONSTRUCTION SITES OR BY CONSTRUCTION ACTIVITIES SHALL BE PLACED, CONVEYED OR DISCHARGED INTO THE

STREET GUTTER OR STORM DRAIN SYSTEM.


2. CONCRETE IMMEDIATELY ADJACENT TO THE FOUNDATION SHALL BE SLOPED AWAY FROM BUILDING AT A SLOPE OF NO LESS THAN 6" (5% SLOPE) IN THE FIRST 10 FEET MEASURED PERPENDICULAR TO THE FACE OF THE WALL. IMPERVIOUS SURFACES WITHIN 10 FEET OF BUILDING SHALL BE SLOPED A MINIMUM OF 2% AWAY FROM BUILDING, PER CRC R401.3

EXCEPTION: WHERE LOT LINES, WALLS, SLOPES OR OTHER PHYSICAL BARRIERS PROHIBIT 6 INCHES OF FALL WITHIN 10 FEET, DRAINS OR SWALES SHALL BE CONSTRUCTED TO ENSURE DRAINAGE AWAY FROM THE STRUCTURE.

ADDITIONS, REMODELS, OR RENOVATIONS OF A SINGLE FAMILY HOME WITH AN EXISTING POOL REQUIRE THE SUCTION OUTLET OF THE EXISTING POOL, SPA, OR TODDLER POOL TO BE UPGRADED SO AS TO BE EQUIPPED WITH AN APPROVED ANTI-ENTRAPMENT COVER MEETING THE CURRENT STANDARDS OF THE ASTM OR ASME PER SECTION 115920 HSC.

HOUSE NUMBER TO BE VISIBLE AND LEGIBLE FROM STREET VIEW. MINIMUM 4" HEIGHT BY 1/2" WIDE. CRC 319

LEGEND & SYMBOLS

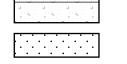

3/16" = 1'-0"

IMPERVIOUS SURFACE - CONCRETE
PERVIOUS SURFACE - LAWN/LANDSCAPE

PROPOSED SITE PLAN

CITY OF COVINA

CORRECTIONS: 11/30/2021

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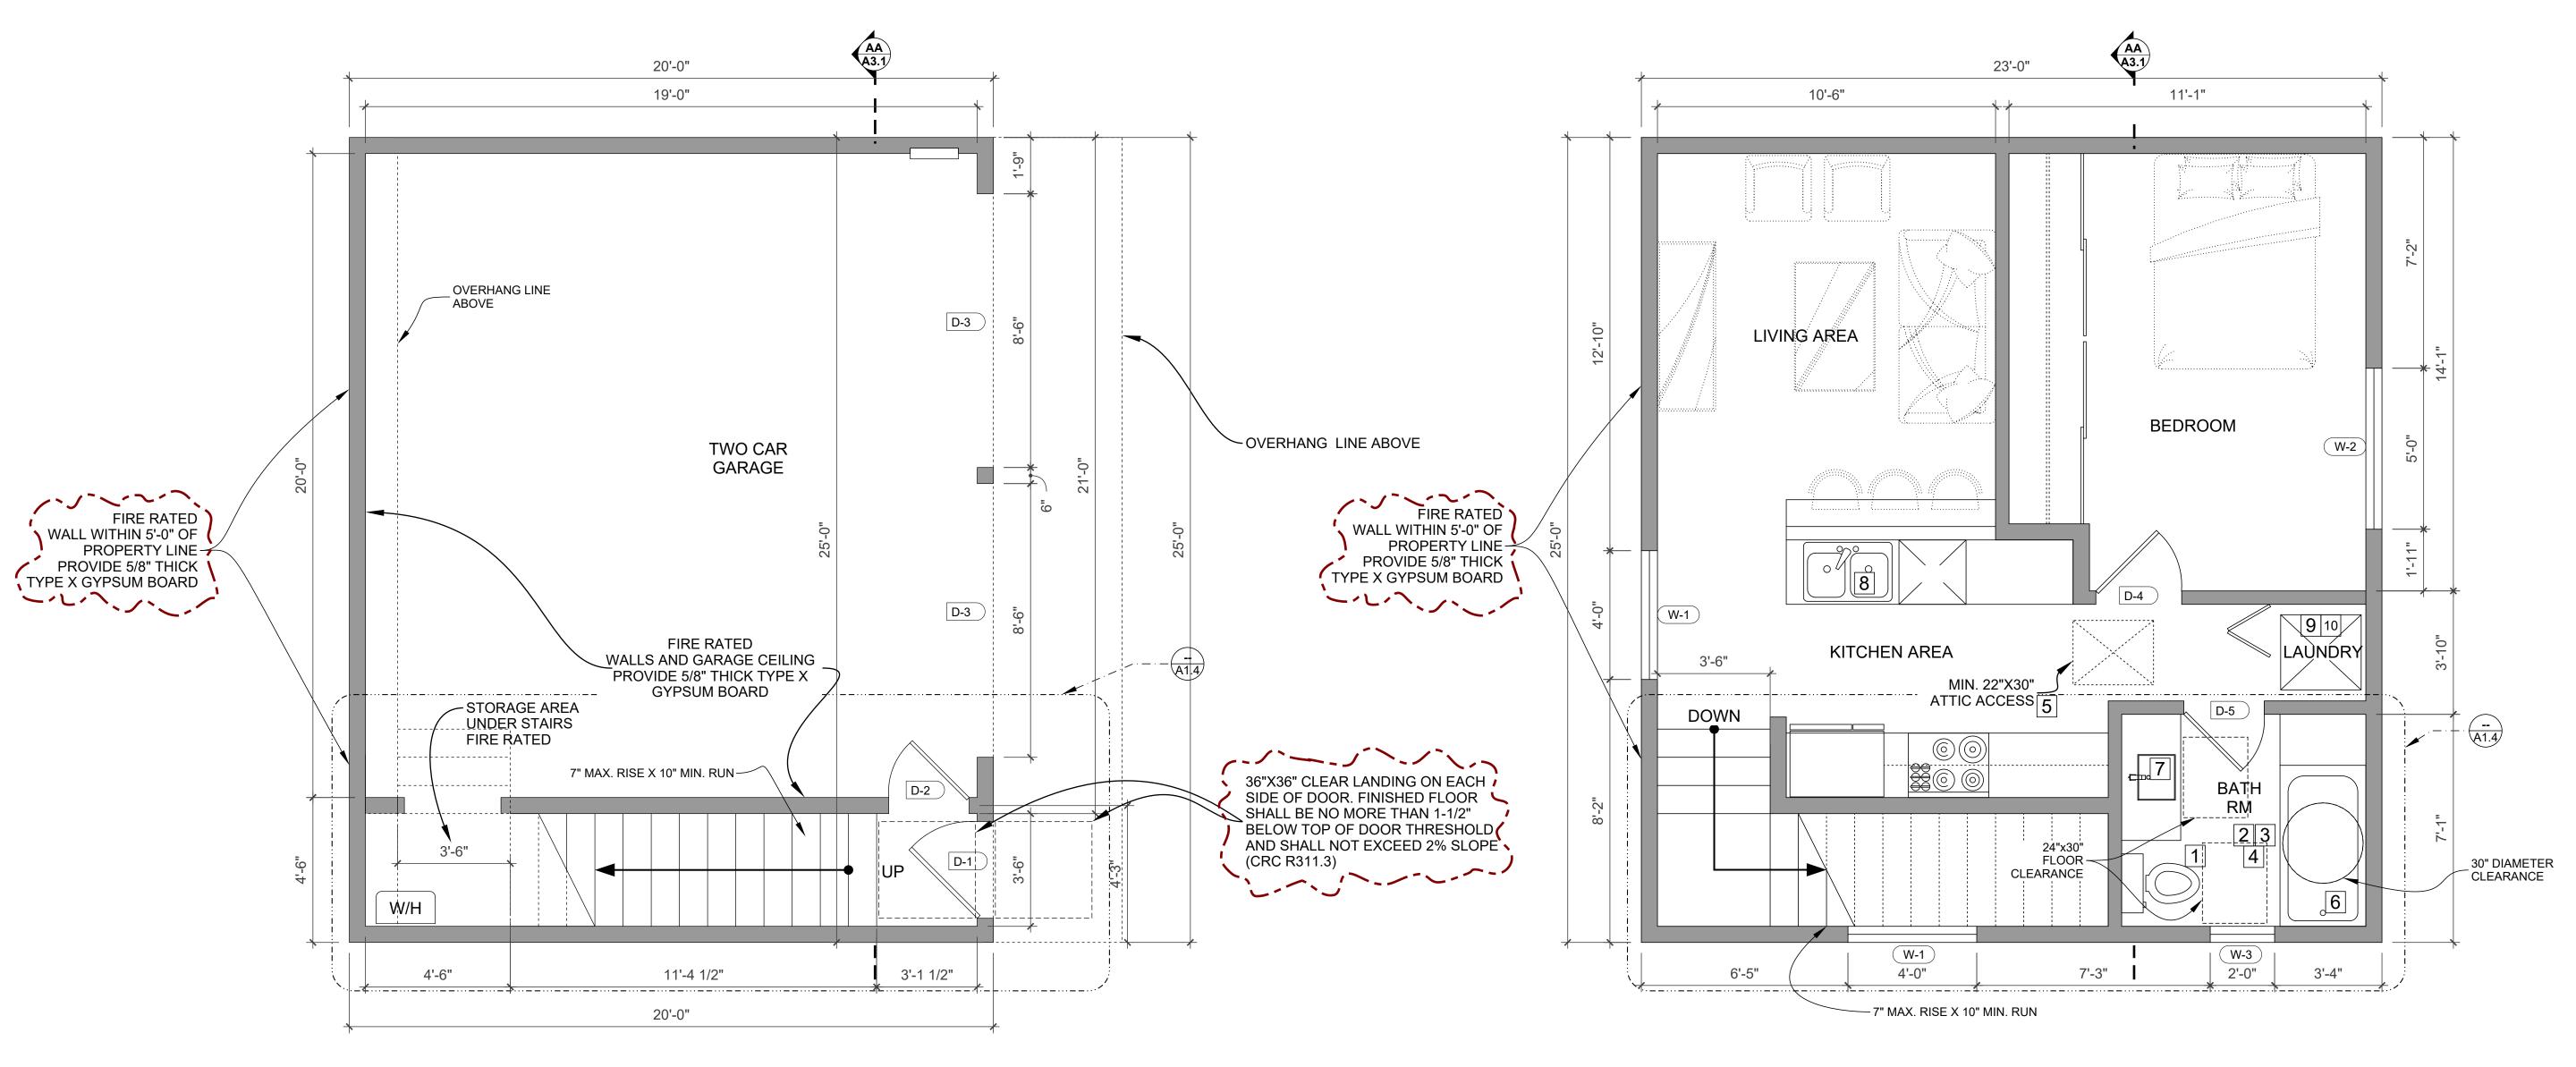
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SCALE

PROJECT NUMBER

04/09/22 **A1.1**



GROUND FLOOR PLAN - GARAGE 3/8" = 1'-0"

UPPER FLOOR PLAN - ADU



	DOOR SCHEDULE									
MARK	Type Mark	WIDTH	HEIGHT	DOOR MATERIAL	FINISH	FRAME MATERIAL	FRAME FINISH	HARDWARE	FIRE RATING	COMMENTS
D1	-	3' 0"	6' 8"	SOLID WOOD	PAINTED	WOOD	PAINTED			······································
D2	1	2' 6"	6' 8"	SOLID WOOD	PAINTED	WOOD	PAINTED	SELF CLOSING	YES	1-3/8" SOLID WOOD OR FIRE RATED - 20 MINUTES. SELF CLOSING CRC 302.5
D3	1	8' 0"	7' 6"	METAL	PAINTED		PAINTED			GARAGE DOOR
D4	ı	2' 8"	6' 8"	WOOD	PAINTED	WOOD	PAINTED			
D5	1	2' 6"	6' 8"	WOOD	PAINTED	WOOD	PAINTED			POCKET DOOR

	WINDOW SCHEDULE									
MARK	Type Mark	WIDTH	HEIGHT	MATERIAL	FINISH	FRAME MATERIAL	HARDWARE	FIRE RATING	COMMENTS	
W1		4' 0"	5' 0"		PAINTED	VINYL				
W2		5' 0"	5' 0"		PAINTED	VINYL				
W3		2' 0"	3' 0"		PAINTED	VINYL		ĺ	TEMPERED GLASS	
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WINDOWS SHALL BE DUAL GLAZED, U-FACTOR: 0.3, SHGC: 0.23 NFRC TEMPORARY LABEL DISPLAYED ON WINDOWS, MUST REMAIN ON THE UNIT UNTIL FINAL INSPECTION HAS BEEN

ENERGY REQUIREMENTS NOTE:

EVERY FENESTRATION PRODUCT SHALL HAVE ATTACHED TO IT A CLEARLY VISIBLE TEMPORARY LABEL THAT LISTS THE U-FACTOR, THE SOLAR HEAT GAIN COEFFICIENT (SHGC) AND VISIBLE TRANSMITTANCE (VT) AND THAT CERTIFIES COMPLIANCE WITH THE AIR LEAKAGE REQUIREMENTS OF SECTION 110.6(a)I. COMPONENT MODELING APPROACH (CMA) AND SITE-BUILT FENESTRATION PRODUCTS SHALL HAVE A LABEL CERTIFICATE THAT LISTS THE U-FACTOR, AND SOLAR HEAT GAIN COEFFICIENT (SHGC) AND THE VISIBLE TRANSMITTANCE (VT). DO NOT REMOVE LABEL UNTIL

PLAN NOTES

ALL DIMENSIONS ARE TO FACE STUDS, CENTER LINE OF STUDS, OR CONCRETE BLOCK THE LOAD RESISTANCE OF GLASS UNDER UNIFORM LOAD SHALL BE DETERMINED IN ACCORDANCE

FIBER-CEMENT SHALL BE USED AS A BASE FOR CERAMIC WALL TILES IN TUB AND SHOWER AREAS AS WELL AS WALL PANELS IN SHOWER AREAS, PER CRC R702.4.2

FLAME SPREAD INDEX AND SMOKE-DEVELOPED INDEX FOR INSULATION SHALL BE IN ACCORDANCE WITH SECTIONS R302.10.I THROUGH R302.10.5

KEY NOTES

WATER CLOSETS (TOILETS) WHICH USE NO MORE THAN 1.28 GALLONS PER FLUSH

ALL SHOWERS AND BATHTUB SHALL HAVE A PRESSURE BALANCE. THERMOSTATIC MIXING VALVE, OR A COMBINATION PRESSURE BALANCE/THERMOSTATIC MIXING TYPE VALVE

BATHTUB, SHOWER FLOORS AND WALLS ABOVE BATHTUBS WITH A SHOWER HEAD, AND SHOWER COMPARTMENTS SHALL BE FINISHED WITH A NON-ABSORBENT SURFACE EXTENDING TO A HEIGHT OF NOT LESS THAN 6 FEET ABOVE FLOOR, PER R307.2

PROVIDE SAFETY GLASS AT BATH PER CRC R308.4.5 SHOWER DOORS SHALL SWING OUT.

ATTIC ACCESS DOORS SHALL HAVE PERMANENTLY ATTACHED INSULATION USING ADHESIVE OR MECHANICAL FASTENERS. THE ATTIC ACCESS SHALL BE GASKETED TO PREVENT AIR LEAKAGE, PER CEC 150.0 (A) 2

6 SHOWER HEADS, NO MORE THAN 1.8 GPM

7 LAVATORY FAUCETS NO MORE THAN 1.2 GPM

8 / KITCHEN FAUCETS NO MORE THAN 1.8 GPM

A DOMESTIC CLOTHES DRYER DUCT SHALL BE OF METAL AND A MINIMUM OF 4 INCHES IN DIAMETER. THE EXHAUST DUCT SHALL NOT EXCEED A TOTAL COMBINED HORIZONTAL AND VERTICAL LENGTH OF 14 FEET, INCLUDING TWO 90 DEGREE ELBOWS. A LENGTH OF 2 FEET SHALL BE DEDUCED FOR EACH 90 DEGREE ELBOW IN EXCESS OF TWO (504.4.2. CMC)

MAKE UP AIR SHALL BE PROVIDED FOR TYPE 1 CLOTHES DRYERS IN ACCORDANCE WITH THE MANUFACTURER'S INSTRUCTIONS (NFPA 54:10.4.3.1) WHERE A CLOSET IS DESIGNED FOR THE INSTALLATION OF A CLOTHES DRYER, AND OPENING OF NOT LESS THAN 100 SQUARE INCHES FOR MAKEUP AIR SHALL BE PROVIDED IN THE DOOR OR BY OTHER APPROVED MEANS. (CMC 504.4.1)

LEGEND & SYMBOLS

NEW WALL EXISTING WALL

D-X DOOR TYPE - REFER TO DOOR SCHEDULE

W-X

WALL TYPE - SEE WALL SCHEDULE

WINDOW TYPE - REFER TO WINDOW SCHEDULE

(-<u>\</u>-\--**PROPOSED**

FLOOR PLANS


CITY OF COVINA


CORRECTIONS: 11/30/2021

DRAWN BY SHEET NUMBER

PROJECT NUMBER

04/09/22 A1.2

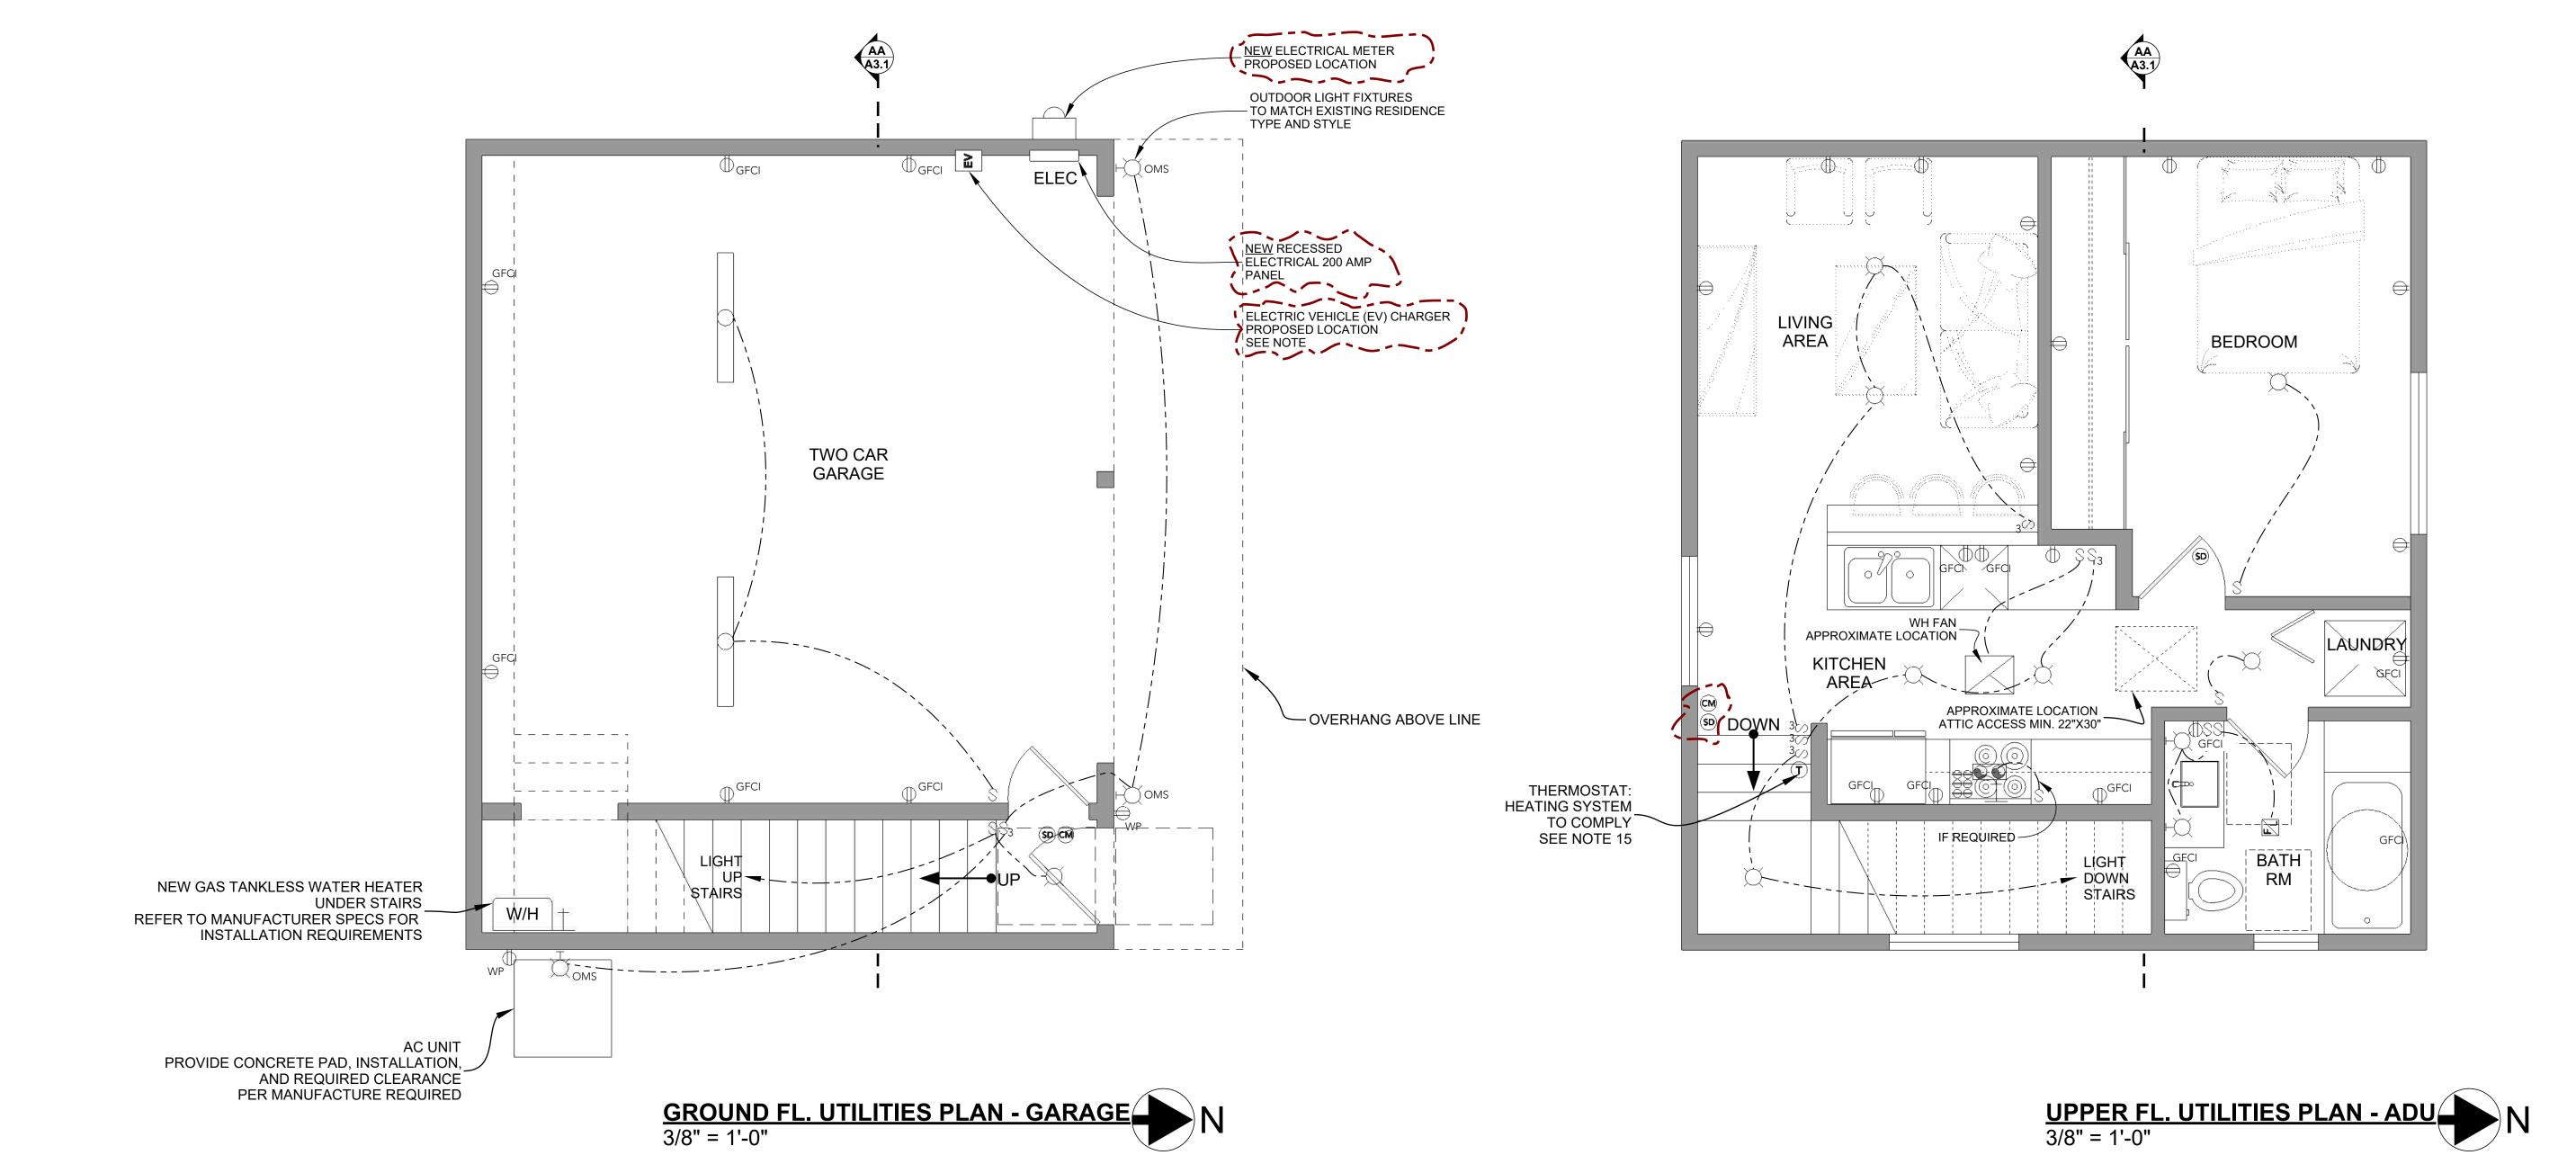

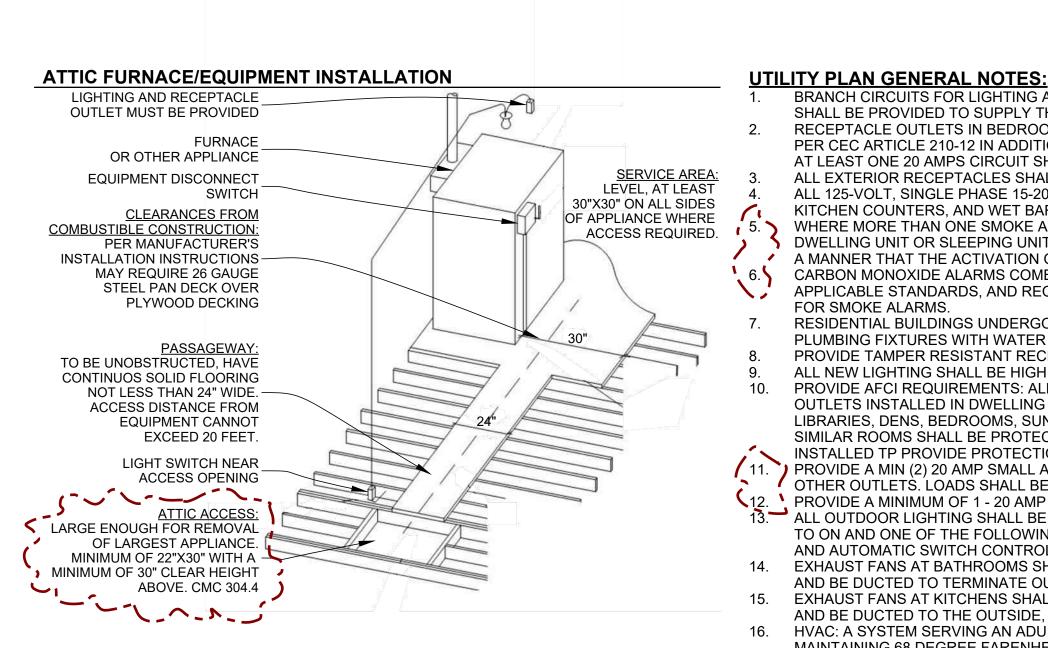

RECEPTACLE OUTLETS IN BEDROOMS SHALL BE PROTECTED BY AN ARC-FAULT CIRCUIT INTERRUPTER PER CEC ARTICLE 210-12 IN ADDITION TO THE NUMBER OF CIRCUITS REQUIRED BY CODE, AT LEAST ONE 20 AMPS CIRCUIT SHALL BE PROVIDED TO SUPPLY THE BATHROOM RECEPTACLE OUTLETS ALL EXTERIOR RECEPTACLES SHALL BE GFCI PROTECTED, PER CEC 210.BB ALL 125-VOLT, SINGLE PHASE 15-20 AMP RECEPTACLES INSTALLED IN BATHROOMS GARAGES, OUTDOORS, KITCHEN COUNTERS, AND WET BAR SINKS. WHERE MORE THAN ONE SMOKE ALARM OR CARBON MONOXIDE ALARM IS REQUIRED TO BE INSTALLED WITHIN AN INDIVIDUAL - REFRIGERATOR DWELLING UNIT OR SLEEPING UNIT, THE SMOKE/CARBON MONOXIDE ALARM SHALL BE INTERCONNECTED IN SUCH A MANNER THAT THE ACTIVATION OF ONE ALARM WILL ACTIVATE ALL OF THE ALARMS IN INDIVIDUAL UNIT. CARBON MONOXIDE ALARMS COMBINED WITH SMOKE ALARMS SHALL COMPLY WITH BOTH SECTIONS R314 AND R315, ALL APPLICABLE STANDARDS, AND REQUIREMENTS FOR LISTING AND APPROVAL BY THE OFFICE OF THE STATE FIRE MARSHAL FOR SMOKE ALARMS. RESIDENTIAL BUILDINGS UNDERGOING ADDITIONS OR IMPROVEMENTS, SHALL REPLACE NON-COMPLIANT PLUMBING FIXTURES WITH WATER CONSERVING PLUMBING FIXTURES PROVIDE TAMPER RESISTANT RECEPTACLES FOR ALL NEW RECEPTACLES, PER CEC 406.12 (A) ALL NEW LIGHTING SHALL BE HIGH EFFICACY, PER CEC TABLE 150.0 (K) 1A PROVIDE AFCI REQUIREMENTS: ALL 120-VOLT, SINGLE PHASE, 15-&20 AMP BRANCH CIRCUITS SUPPLYING OUTLETS INSTALLED IN DWELLING UNIT KITCHENS, DINING ROOMS, FAMILY ROOMS, LIVING ROOMS, PARLORS, LIBRARIES, DENS, BEDROOMS, SUNROOMS, REC. ROOMS, CLOSETS, LAUNDRY AREAS, HALLWAYS AND SIMILAR ROOMS SHALL BE PROTECTED BY A LISTED ARC-FAULT CIRCUIT INTERRUPTER, COMBINATION TYPE, INSTALLED TP PROVIDE PROTECTION OF THE BRANCH CIRCUIT, PER CEC 210.12. PROVIDE A MIN (2) 20 AMP SMALL APPLIANCE CIRCUITS FOR THE KITCHEN COUNTER TOPS. SUCH CIRCUITS SHALL HAVE NO OTHER OUTLETS. LOADS SHALL BE BALANCED. CEC 210-52 (B)(2) 12. PROVIDE A MINIMUM OF 1 - 20 AMP LAUNDRY BRANCH CIRCUIT. SUCH CIRCUIT SHALL HAVE NO OTHER OUTLETS CEC 210-23(a) ALL OUTDOOR LIGHTING SHALL BE CONTROLLED BY A MANUAL ON AND OFF SWITCH THAT DOES NOT OVERRIDE

BRANCH CIRCUITS FOR LIGHTING AND APPLIANCES, INCLUDING MOTOR-OPERATED APPLIANCES

SHALL BE PROVIDED TO SUPPLY THE LOADS COMPUTED IN ACCORDANCE WITH SECTION 220-3 OF THE CEC.

TO ON AND ONE OF THE FOLLOWING: CONTROLLED BY PHOTOCELL AND MOTION SENSOR, PHOTO CONTROL AND AUTOMATIC SWITCH CONTROL, ASTRONOMICAL TIME CLOCK, OR ENERGY MANAGEMENT CONTROL SYSTEM. EXHAUST FANS AT BATHROOMS SHALL BE ENERGY STAR COMPLIANT WITH A MINIMUM VENTILATION RATE OF 50 CFM AND BE DUCTED TO TERMINATE OUTSIDE THE BUILDING, PER CGBSC 4.506.1 EXHAUST FANS AT KITCHENS SHALL BE ENERGY STAR COMPLIANT WITH A MINIMUM VENTILATION RATE OF 100 CFM

AND BE DUCTED TO THE OUTSIDE, RANGE HOODS MUST VENT OUTSIDE. ALUMINUM FLEX DUCT NOT ALLOWED. HVAC: A SYSTEM SERVING AN ADU MUST HAVE ITS OWN THERMOSTAT. HEATING SYSTEMS MUST BE CAPABLE OF MAINTAINING 68 DEGREE FARENHEIT AT A POINT THREE FEET ABOVE THE FLOOR AND TWO FEET FROM THE EXTERIOR WALLS IN HABITABLE ROOMS. SEE TITLE 24 FOR HEATING AND COOLING LOAD CALCULATIONS. NO BUILDING SEWER OR OTHER DRAINAGE PIPING OR PART THEREOF, CONSTRUCTED OF MATERIALS OTHER THAN THOSE APPROVED FOR USE UNDER OR WITHIN A BUIDLING. SHALL BE INSTALLED UNDER OR WITHIN 2 FEET OF A BUILDING OR STRUCTURE, OR LESS THAN 1 FOOT BELOW THE SURFACE OF THE GROUND. CPC 312.3 18. PROVIDE ELECTRICAL CIRCUIT FOR EV CHARGER. INSTALL A LISTED RACEWAY TO ACCOMMODATE A DEDICATED 208/240 VOLT BRANCH CIRCUIT. THE RACE WAY SHALL NOT BE LESS THAN TRADE SIZE 1 (NOMINAL 1 INCH INSIDE DIAMETER). THE RACEWAY SHALL ORIGINATE AT THE SERVICE OR SUBPANEL AND SHALL TERMINATE INTO A LISTED CABINET, OR BOX IN CLOSE PROXIMITY TO THE PROPOSED LOCATION OF AN EV CHARGER.

CGBCS 4.106.4.1

ELECTRICAL LOAD CALCULATION SCHEDULE (TOTAL 1020 SF) COMPUTED LOAD: - SF OF HOUSE x 3W/SF 3060 - SMALL APPLIANCE CIRCUITS 3000 **APPLICATION OF DEMAND:** 1000 - GARBAGE DISPOSAL 1500 - DISHWASHER - GAS WASHER/DRYER 3000 - MICROWAVE 1200 1200 - RANGE 200 200 - GAS TANKLESS WH - A/C UNIT 6000 200 - OUTSIDE LIGHTING - EV CHARGER 9000 - 8000W @ 100% 8000 - REMAINDER @ 40% TOTAL 41,547 WATTS 200 AMP @ 120/240V, 1-PHASE, 3 WIRE ·----**EQUIPMENT NOTES** REFER TO ALL MANUFACTURER'S INSTALLATION REQUIREMENTS AND MANUFACTURER REQUIRED CLEARANCES FOR INSTALLATION. WHOLE HOUSE FAN: QUIETCOOL ENERGY SAVER LINE, MODEL: QC ES-2250

HVI-916 Airflow (for CA Title 24 New Construction): HI 1850 CFM / LOW 1420 CFM KITCHEN LOCAL EXHAUST: GE 1.6 CU. FT. OVER THE RANGE MICROWAVE OVEN, MODEL: JVM3160RFSS

300 CFM, EXTERNALLY VENTED AT INSTALLATION WATER HEATER: TAKAGI 200 SERIES TANKLESS WH, MODEL: TK-110U-I (INDOOR) UEF: 0.82

CENTRAL AC UNIT: TRANE XB SERIES, MODEL: 4TTB3060D 4 TON, SEER 14

CALIFORNIA ENERGY COMMISION FLOW RATE STANDARDS: 1. WATER CLOSETS: 1.28 GPM 2. SHOWERHEADS: 1.8 GPM 1.2 GPM 3. LAVATORY SINK FAUCETS: 4. KITCHEN FAUCETS: 1.8 GPM

LEGEND AND SYMBOLS FLOURESCEN LIGHT FIXTURE WALL MOUNTED LIGHT FIXTURE OMS OUTDOOR MOTION SENSOR LIGHT FIXTURE CEILING LIGHT RECEPTACLE OUTLET GFCI RECEPTACLE OUTLET - FAULT CIRCUIT INTERRUPTERS RECEPTACLE OUTLET - WATER PROOFED SMOKE DETECTOR CARBON MONOXIDE DETECTOR EXHAUST FAN WITH LIGHT (50 CFM MIN.) LIGHT SWITCH LIGHT 3 WAY SWITCH THERMOSTAT **FUEL GAS** RANGE HOOD EXHAUST FAN (100 CFM MIN.) WHOLE HOUSE FAN EV ELECTRIC VEHICLE (EV) CHARGER

- COUNTAIN ON THE STATE OF THE CITY OF COVINA CORRECTIONS: 11/30/2021 ·-<u>\-</u>-\-<u>-</u>


PROPOSED UTILITIES PLANS


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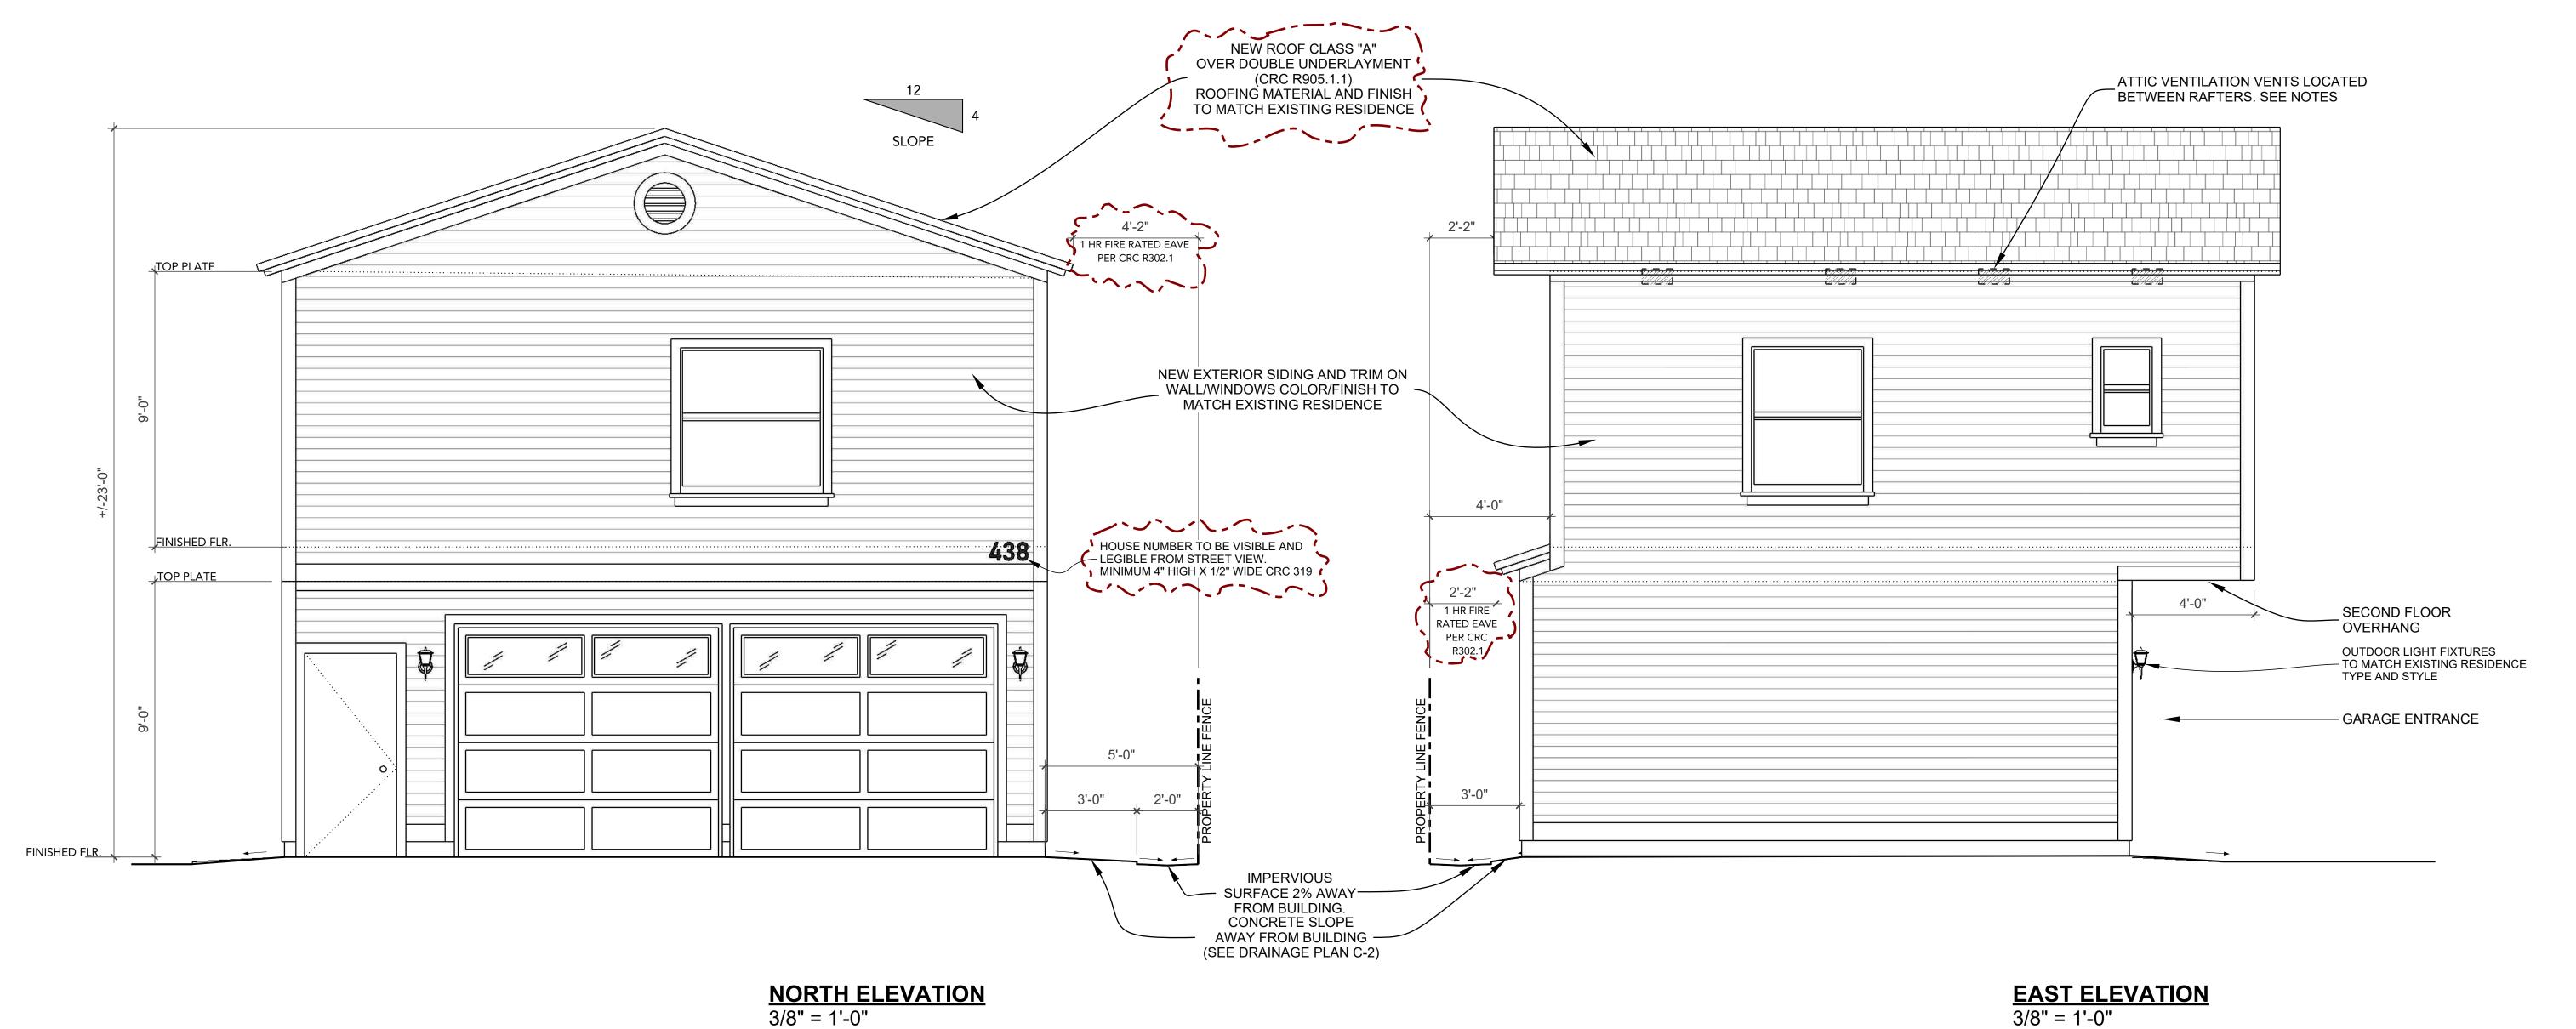
SHEET NUMBER

04/09/22 **A1.3**





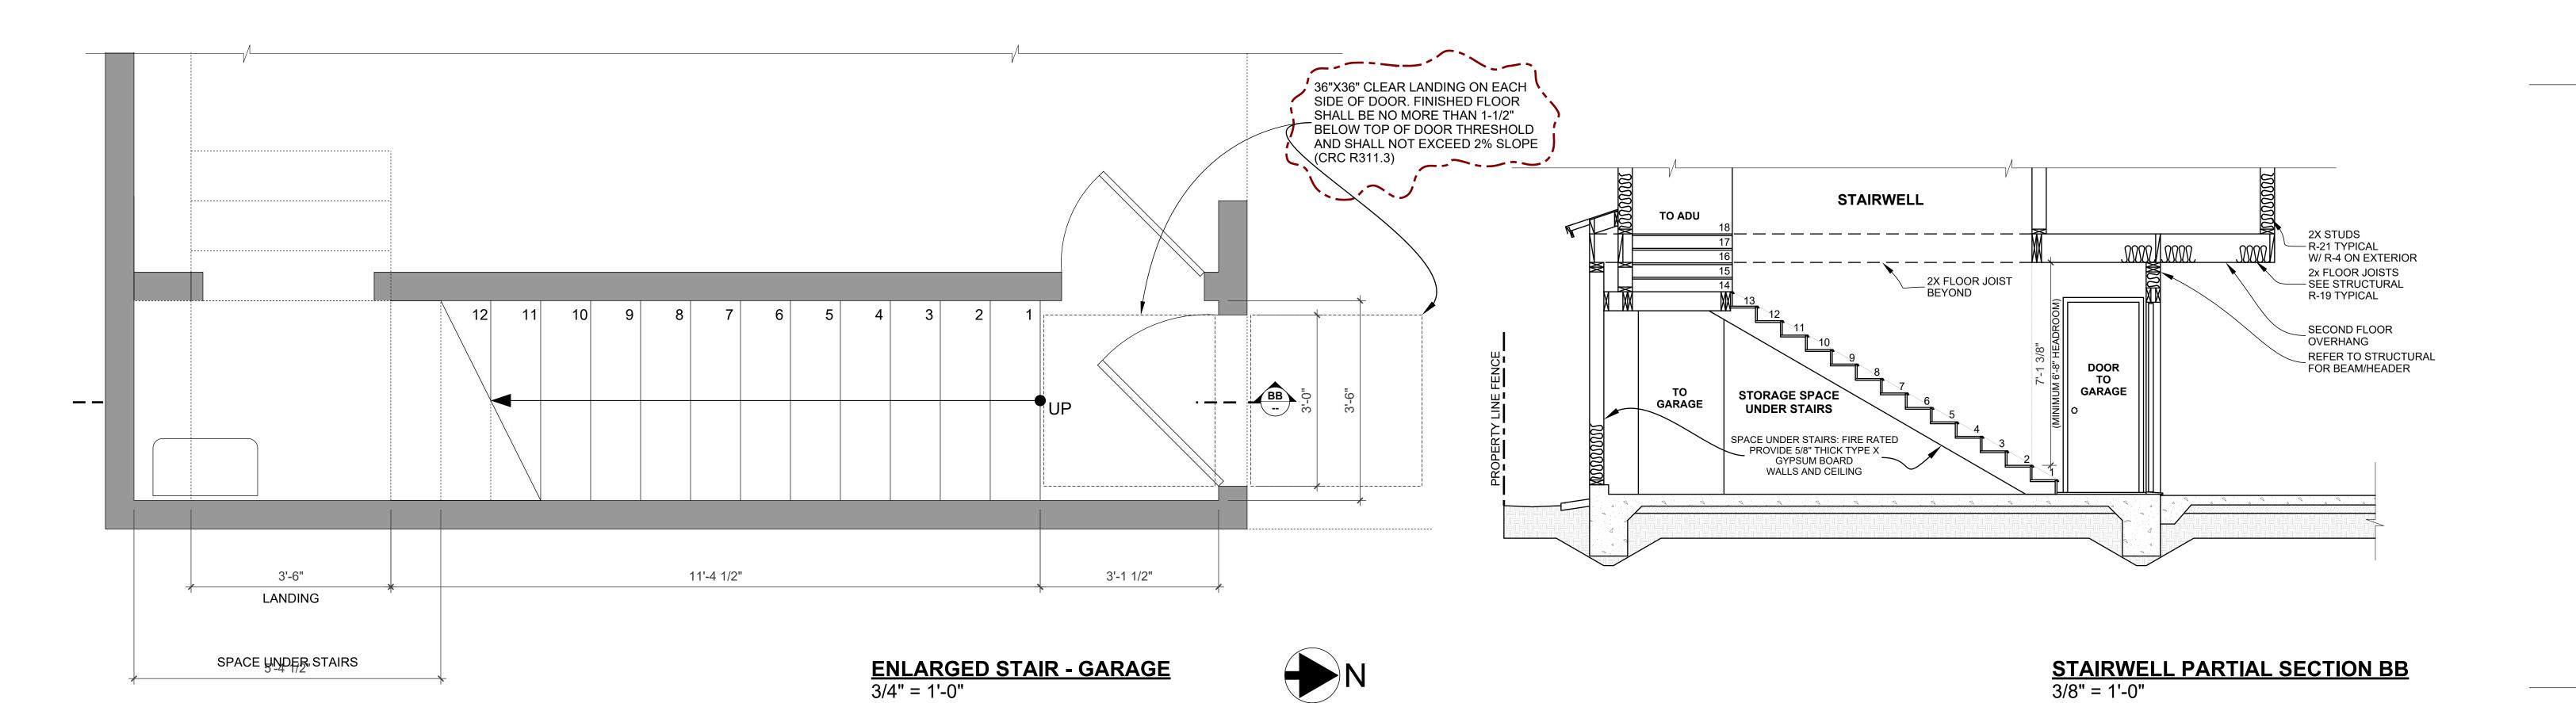

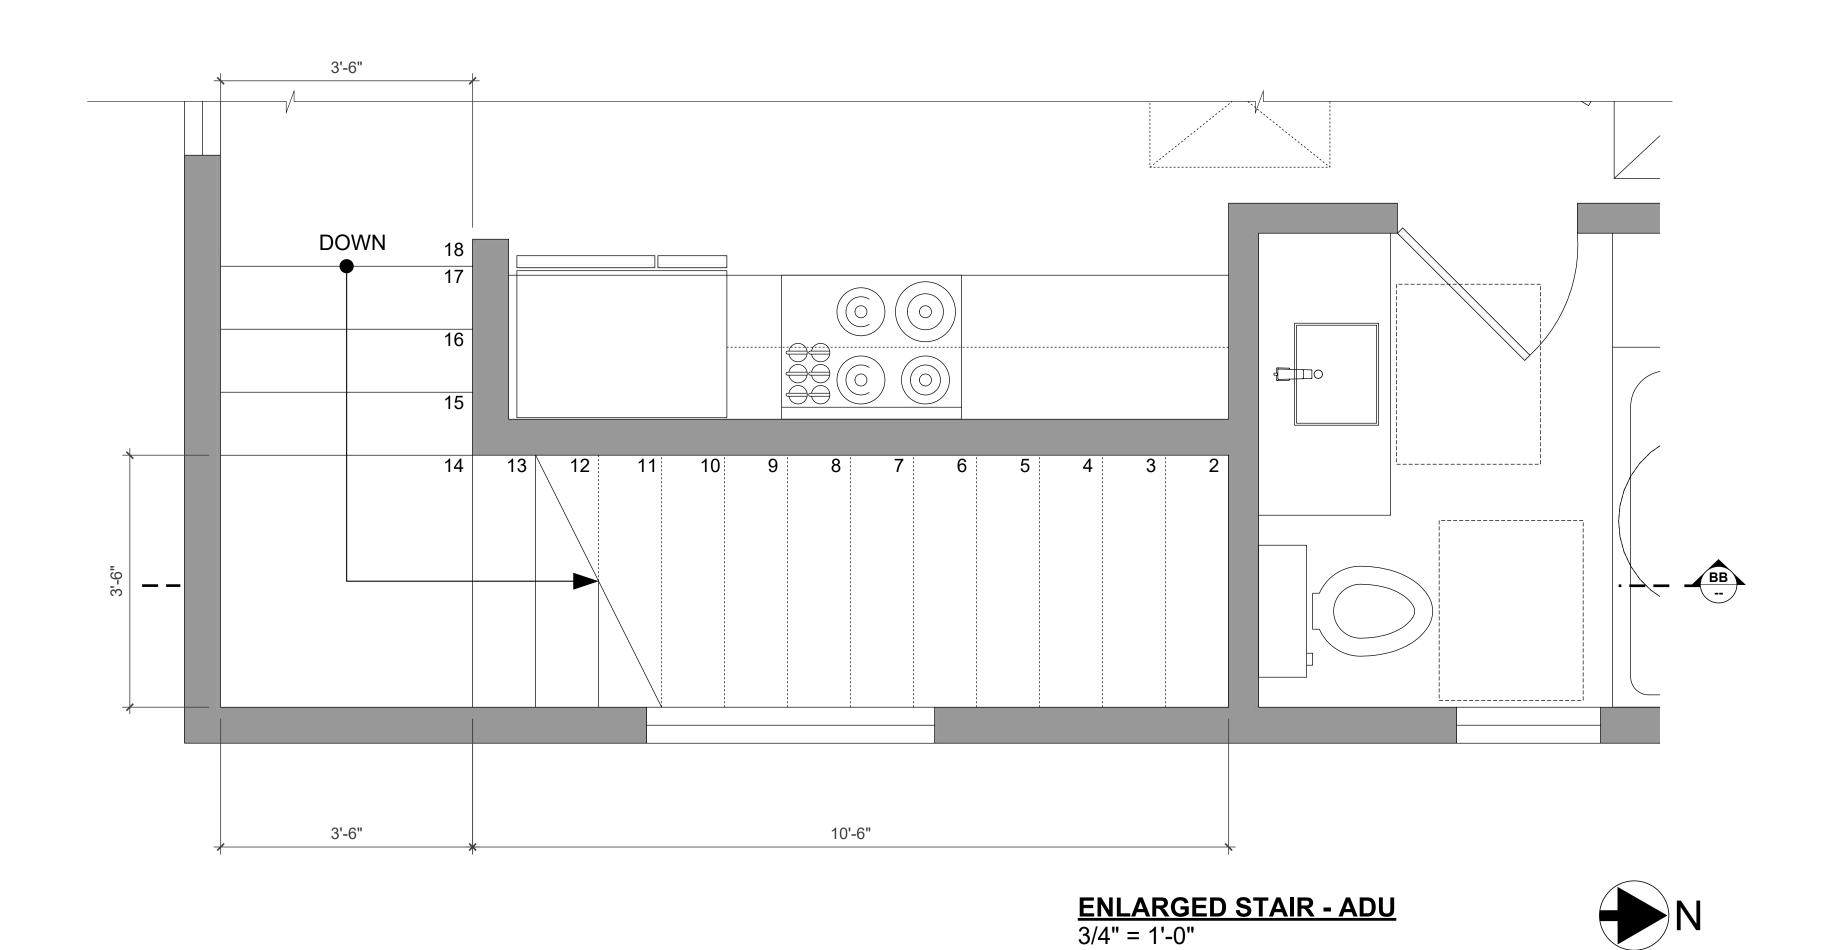

NOTES:
1. PROPOSED GARAGE AND ADU: ARCHITECTURE, MATERIAL FINISH AND COLOR SHOULD MATCH EXISTING RESIDENCE

ATTIC VENTILATION:
2. THE REQUIRED VENTILATION AREA RATIO IS 1/150 OF THE ATTIC AREA OR 1/300 OF ATTIC AREA IF AT LEAST HALF OF THE VENT AREA IS LOCATED MORE THAN 3 FEET ABOVE EAVE VENTS (PROVIDING THE REMAINING PORTION OF THE

OPENINGS SHALL HAVE 1/4" CORROSION RESISTANT METAL MESH COVERINGS.


ATTIC VENTILATION CALCULATION: ATTIC AREA: 600 SF/150 = 4 SQ. FT. REQUIRED

CITY OF COVINA CORRECTIONS: 11/30/2021 SHEET TITLE

> PROPOSED **EXTERIOR ELEVATIONS**

> > PROJECT NUMBER

04/09/22 **A2.1**

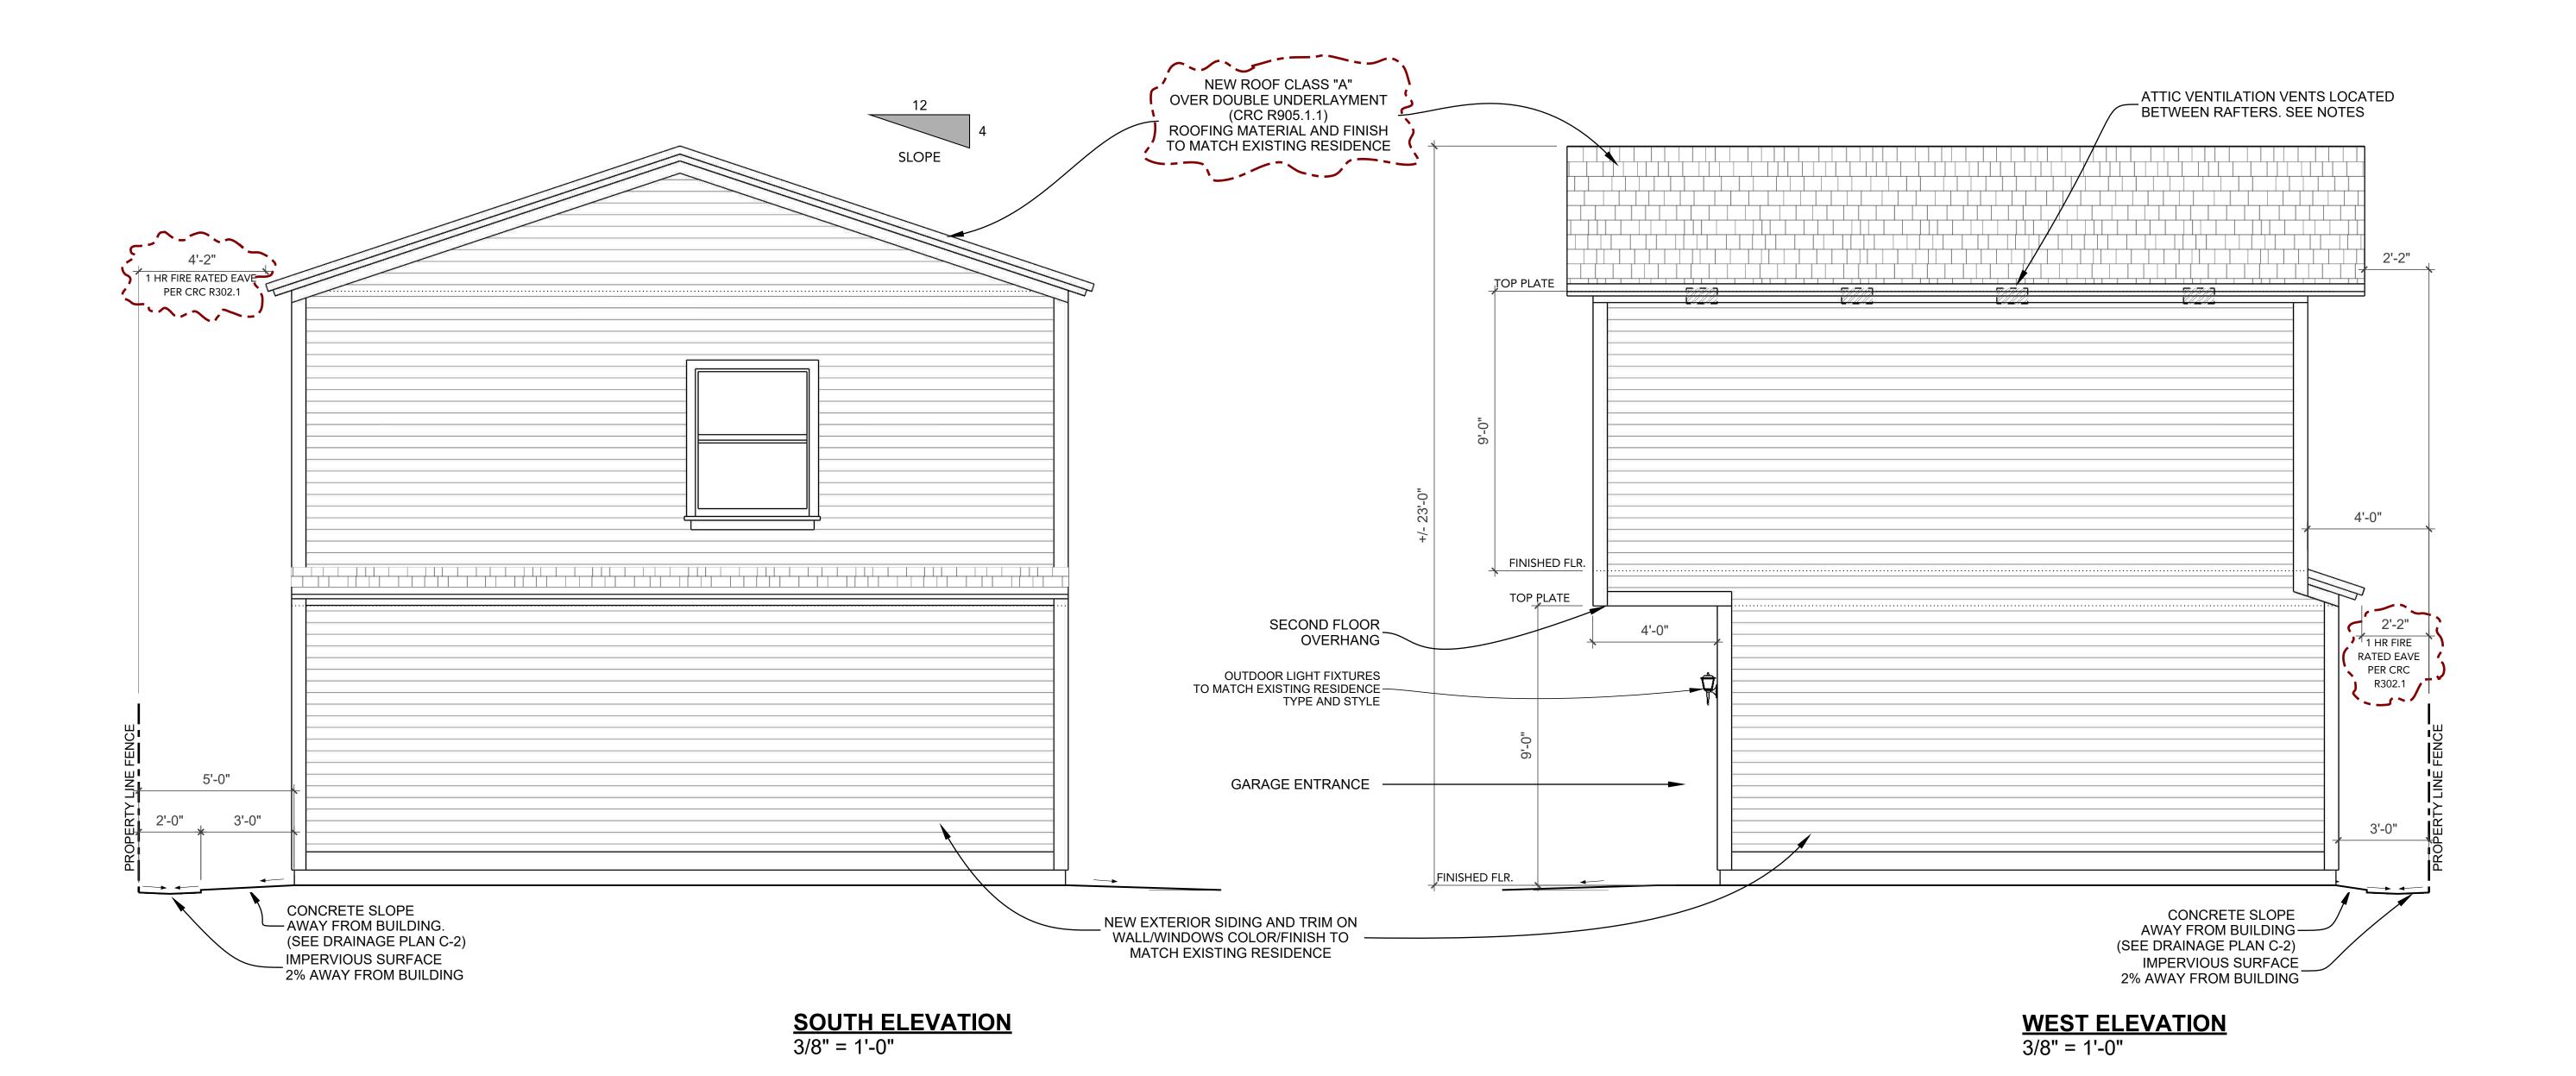

TEO.

NOTES:
1. PROPOSED GARAGE AND ADU: ARCHITECTURE, MATERIALS AND COLOR SHOULD MATCH EXISTING RESIDENCE

ATTIC VENTILATION:

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3. OPENINGS ŚHALL HAVE 1/4" CORROSION RESISTANT METAL MESH COVERINGS.

ATTIC VENTILATION CALCULATION:
ATTIC AREA: 600 SF/150 = 4 SF REQUIRED
8 VENTS @ .5 SF REQUIRED

CITY OF COVINA
CORRECTIONS: 11/30/2021

PROPOSED EXTERIOR ELEVATIONS


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SCALE

PROJECT NUMBER


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04/09/22 **A2.2**



PROPOSED ROOFPLAN - ADU 3/8" = 1'-0"

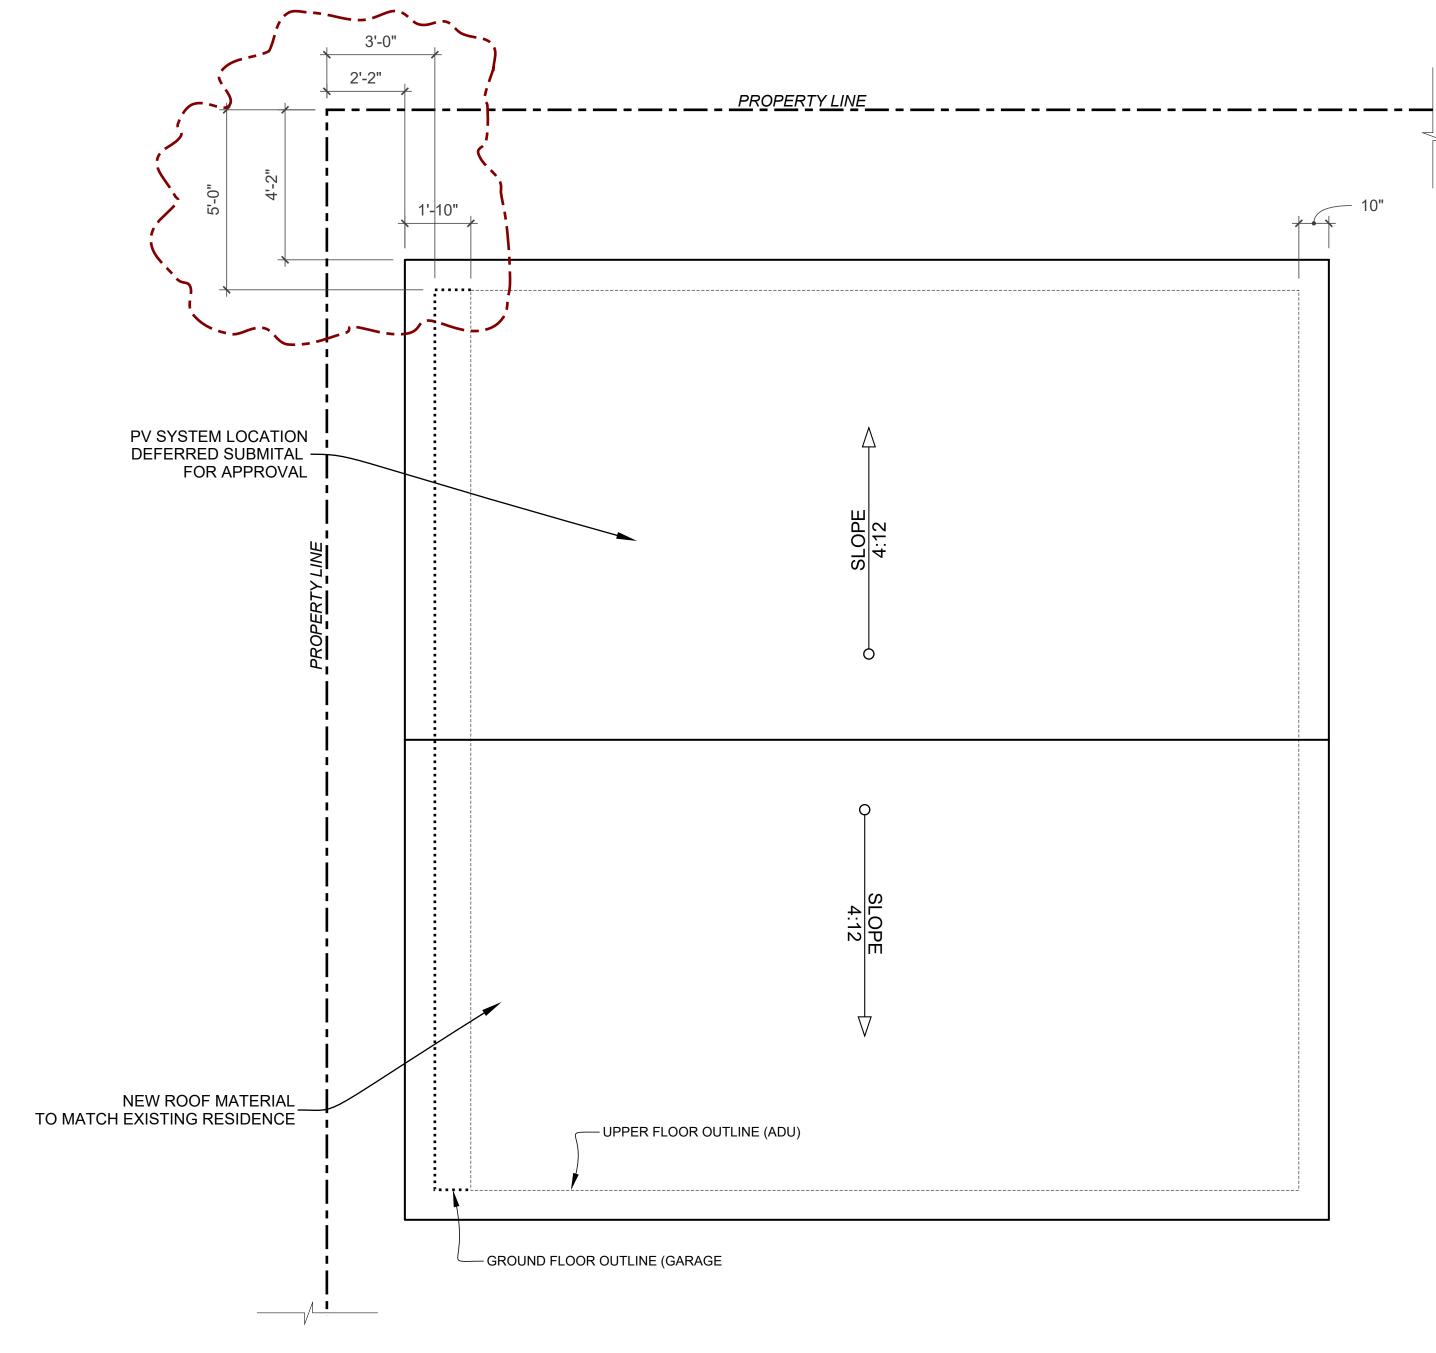

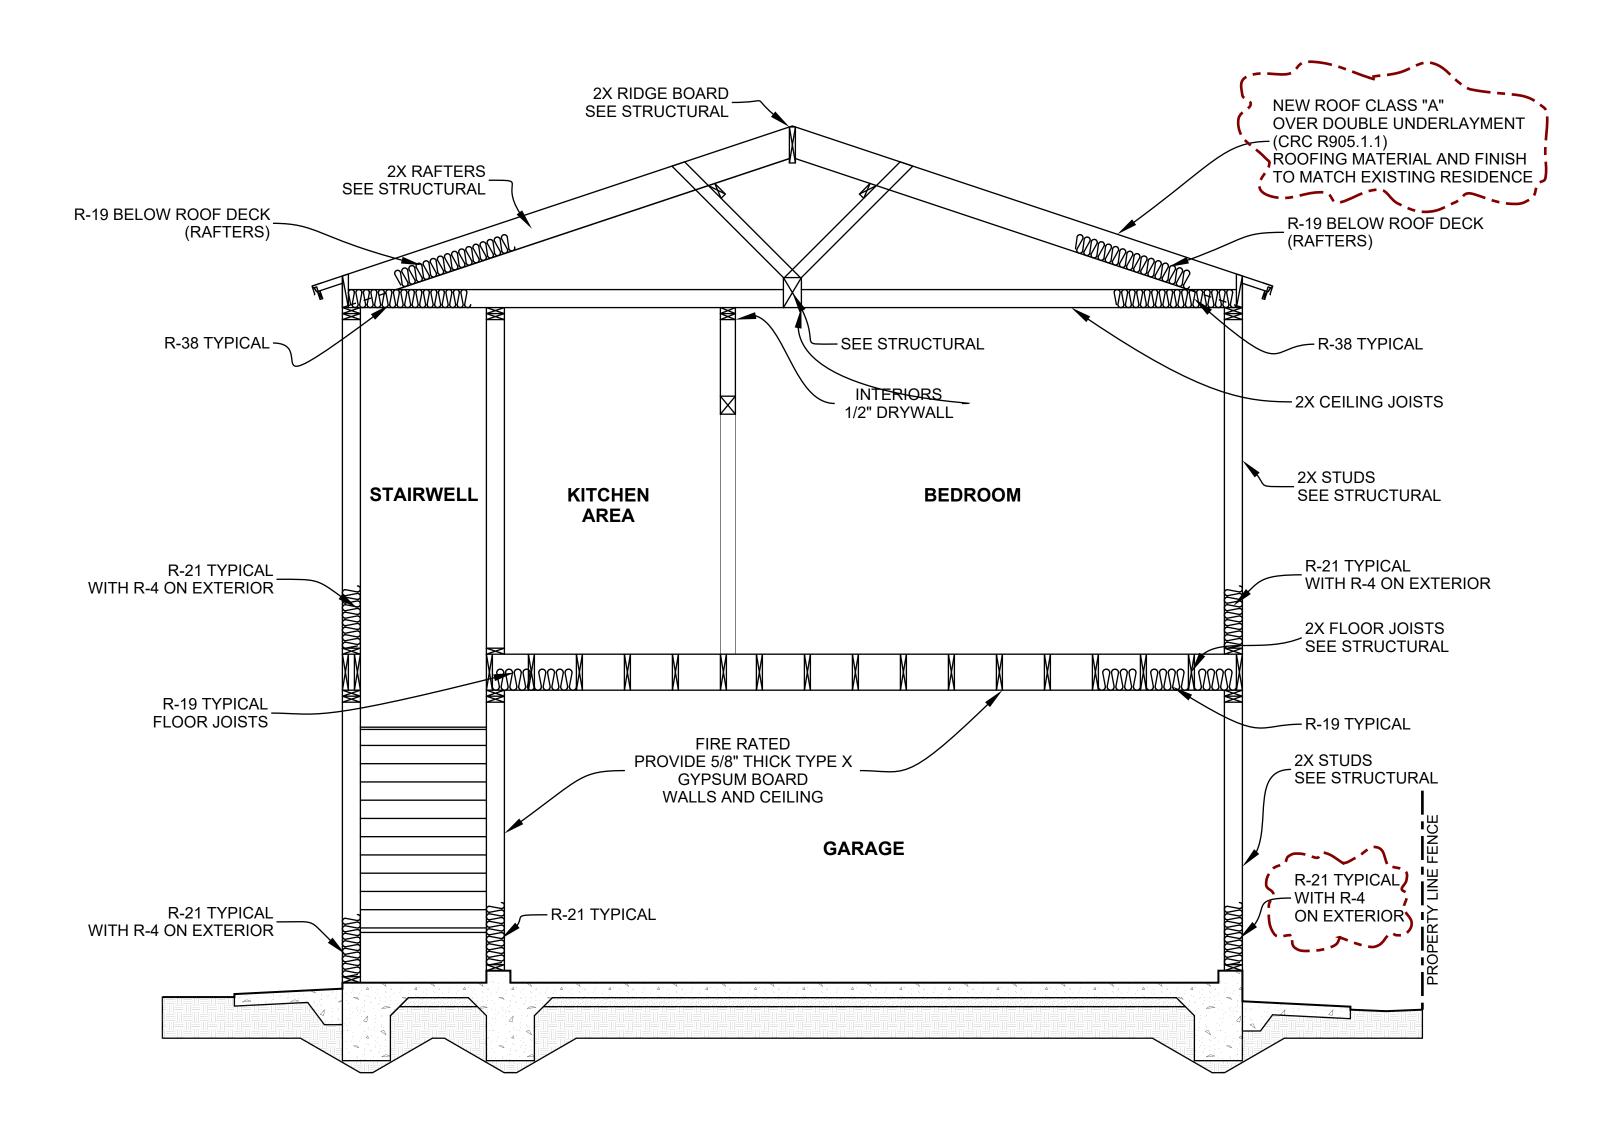

SECTION AA 3/8" = 1'-0"

NOTES:
1. PROPOSED GARAGE AND ADU: ARCHITECTURE, MATERIALS AND COLOR SHOULD MATCH EXISTING RESIDENCE.

ATTIC VENTILATION:

THE REQUIRED VENTILATION AREA RATIO IS 1/150 OF THE ATTIC AREA OR 1/300 OF ATTIC AREA IF AT LEAST HALF OF THE VENT AREA IS LOCATED MORE THAN 3 FEET ABOVE EAVE VENTS (PROVIDING THE REMAINING PORTION OF THE

OPENINGS ŚHALL HAVE 1/4" CORROSION RESISTANT METAL MESH COVERINGS.

ATTIC VENTILATION CALCULATION: ATTIC AREA: 600 SF/150 = 4 SF REQUIRED 8 VENTS @ .5 SF REQUIRED

STRUCTURAL:
4. REFER TO STRUCTURAL DRAWINGS FOR ALL FRAMING AND FOUNDATION DETAILS AND INFORMATION NOTES.


CITY OF COVINA CORRECTIONS: 11/30/2021 (-<u>\</u>-\--


> PROPOSED SECTION AND **ROOF PLAN**

> > PROJECT NUMBER


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04/09/22 **A3.1**




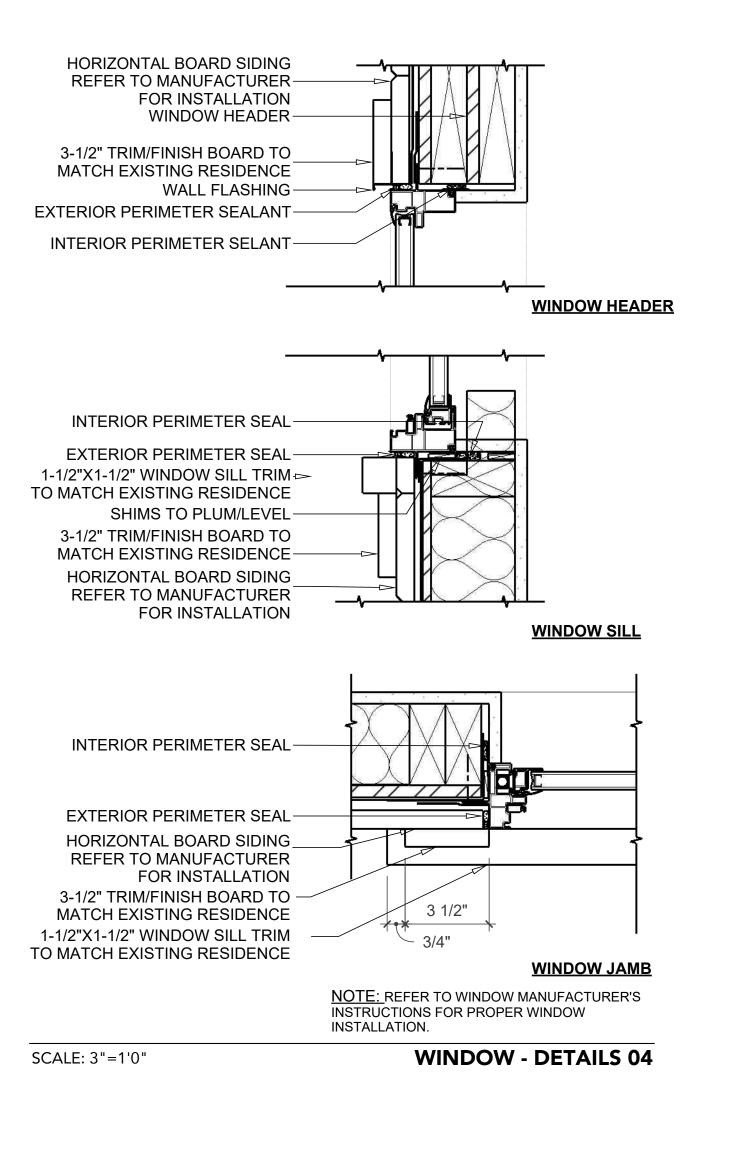


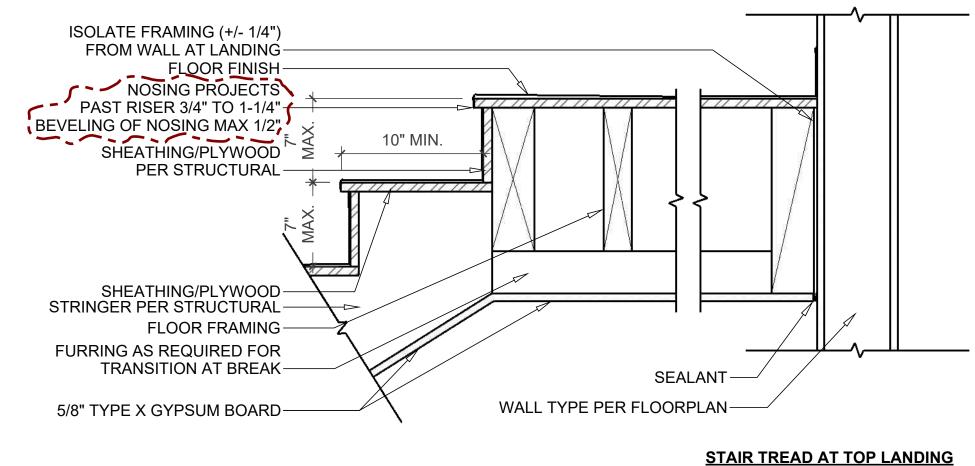
10" MIN. NOSING PROJECTS PAST RISER 3/4" TO 1-1/4" SHEATHING/PLYWOOD PER STRUCTURAL-FLOOR FRAMING PER STRUCTURAL 5/8" TYPE X GYPSUM BOARD

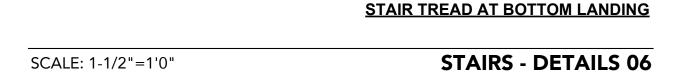

STAIRS HANDRAIL - DETAILS 07

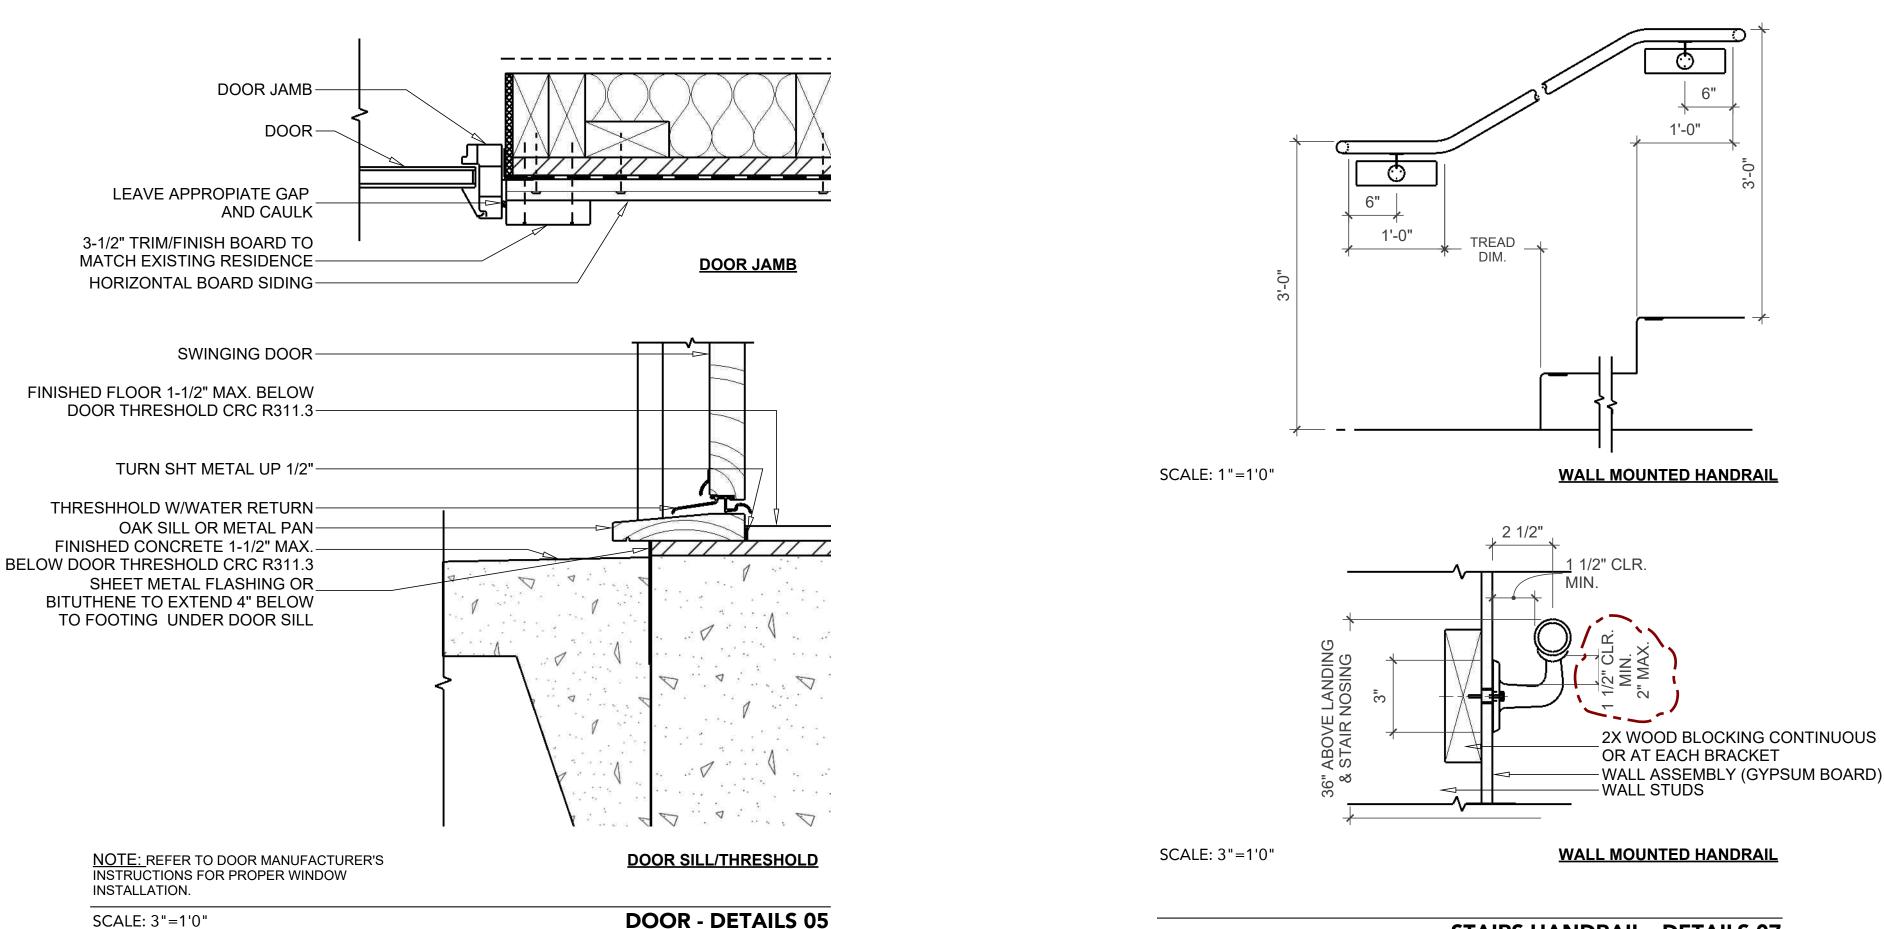


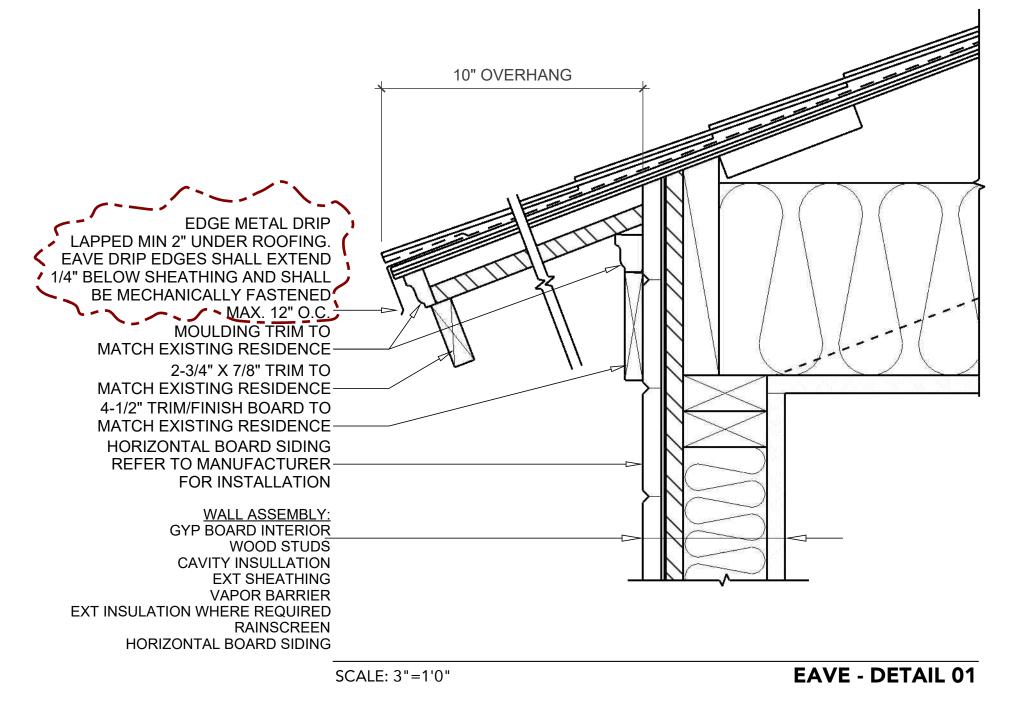

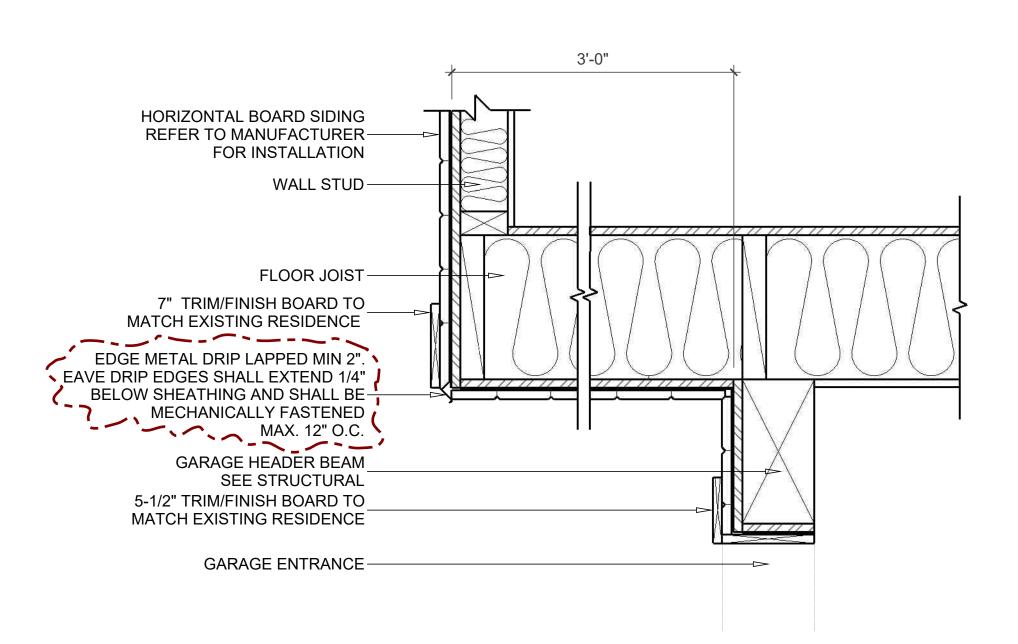


SCALE: 1-1/2"=1'0"

SCALE: 3"=1'0"

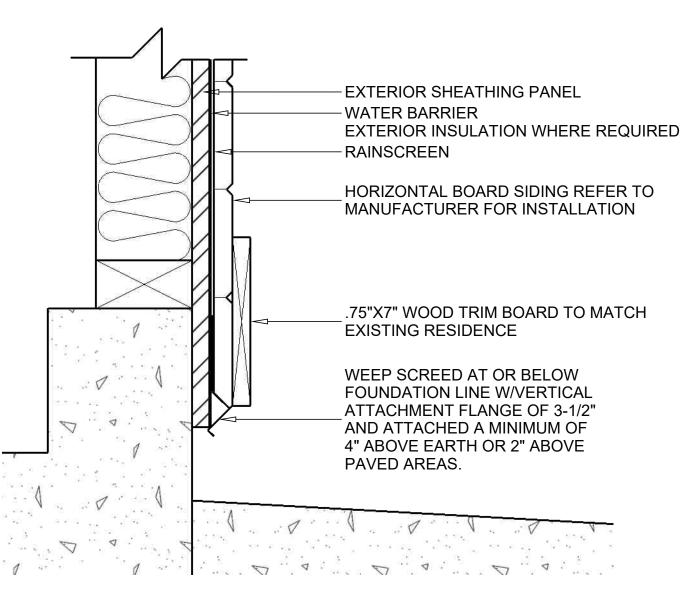

SECOND FLOOR OVERHANG - DETAIL 02

PAVING TO SILL - DETAIL 03

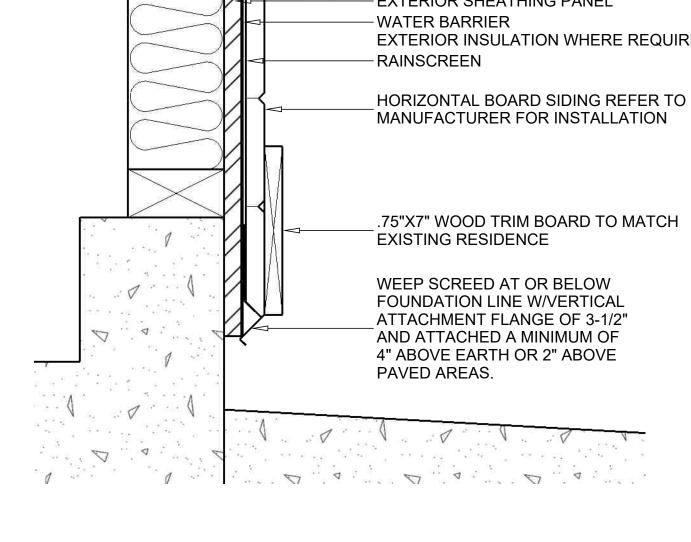

04/09/22 A 4.0

PROJECT NUMBER

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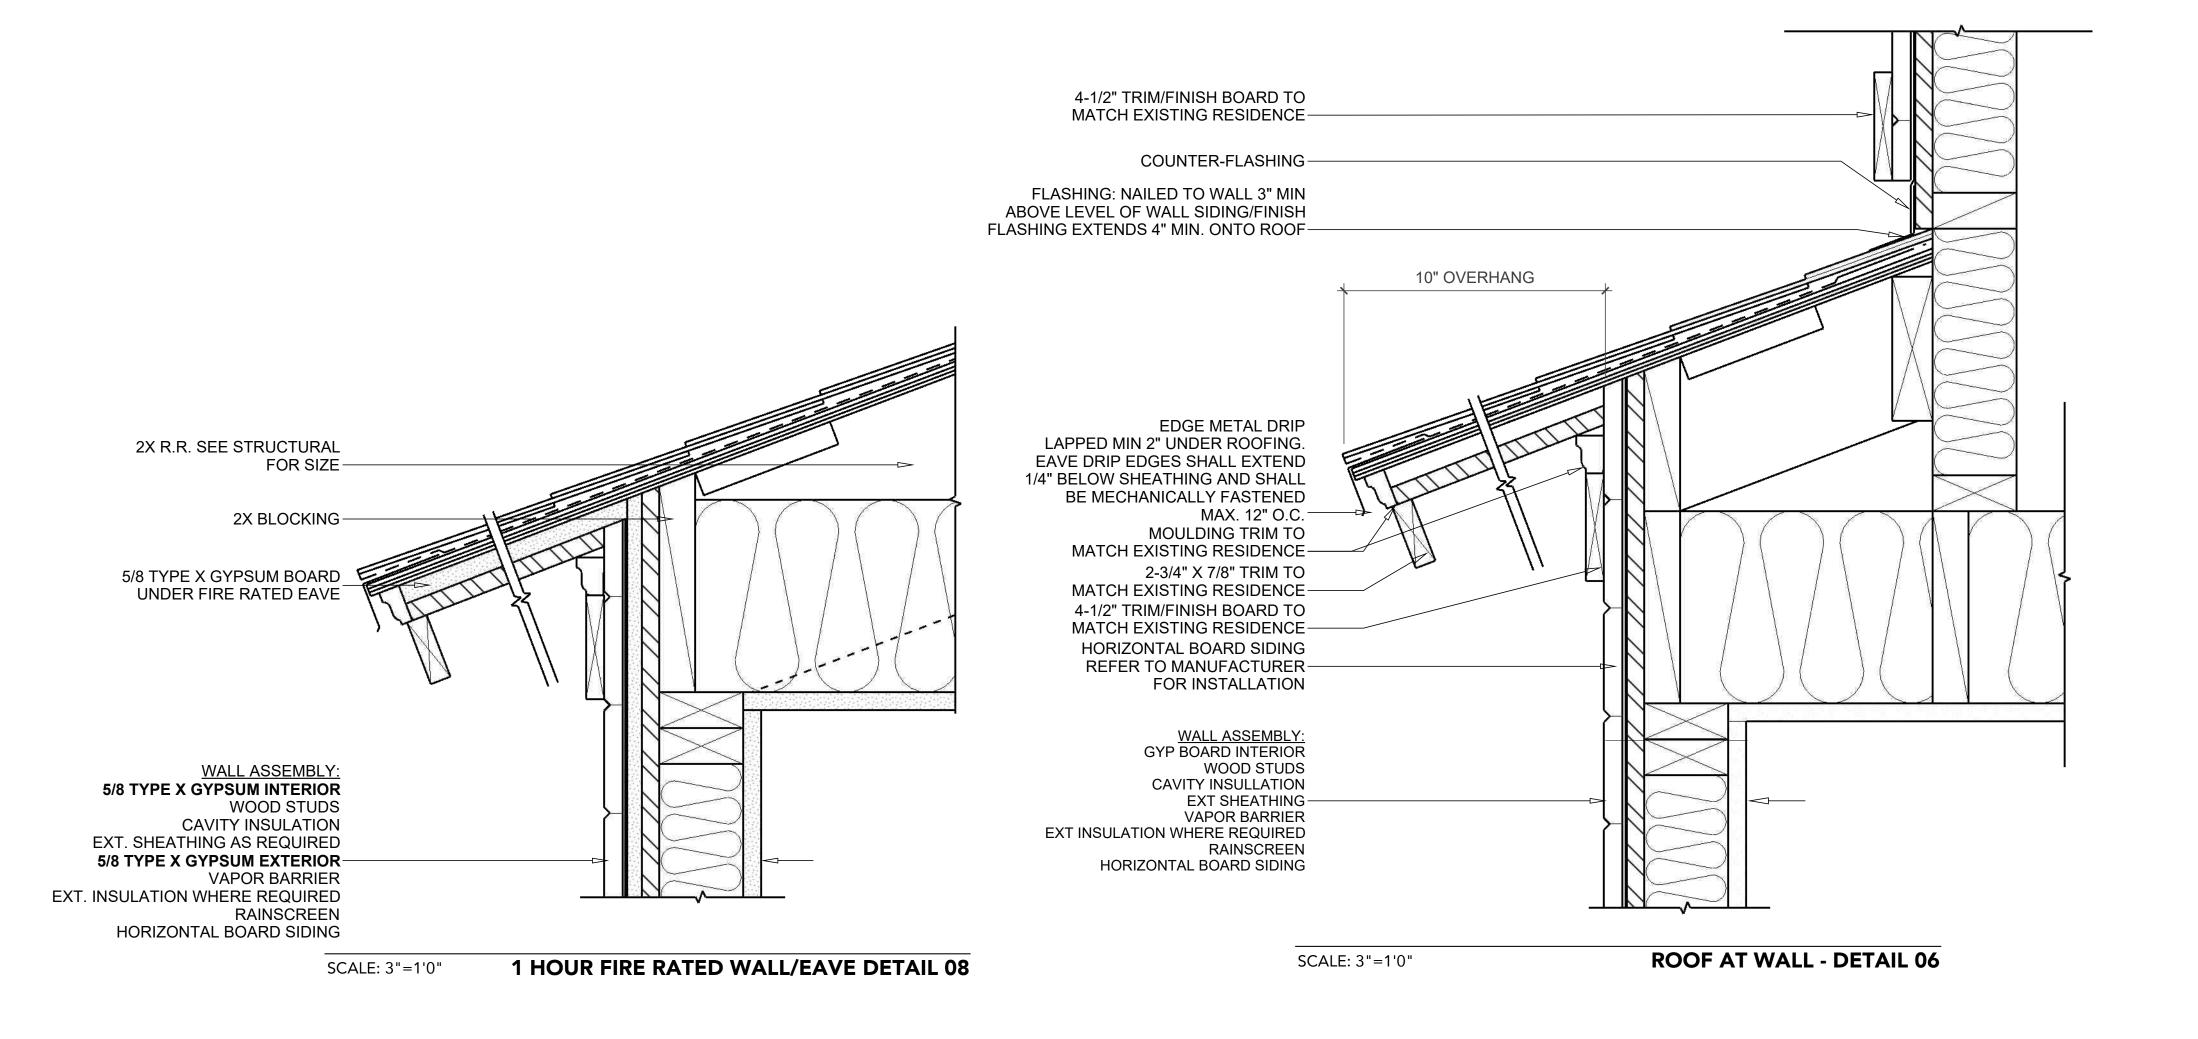
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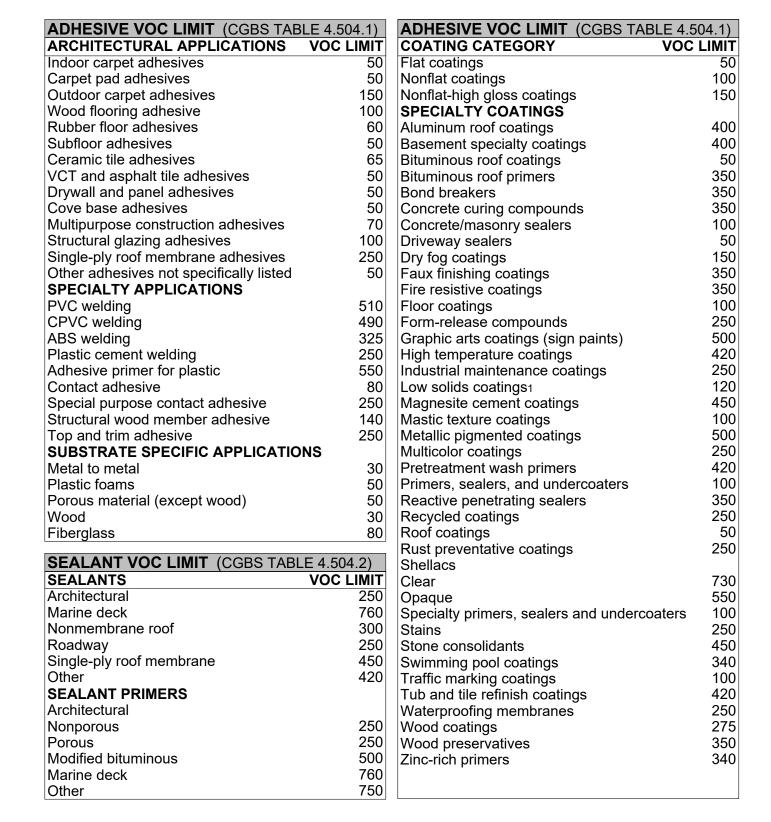
CITY OF COVINA

CORRECTIONS: 11/30/2021 ·----


DETAILS

PREPARED BY:







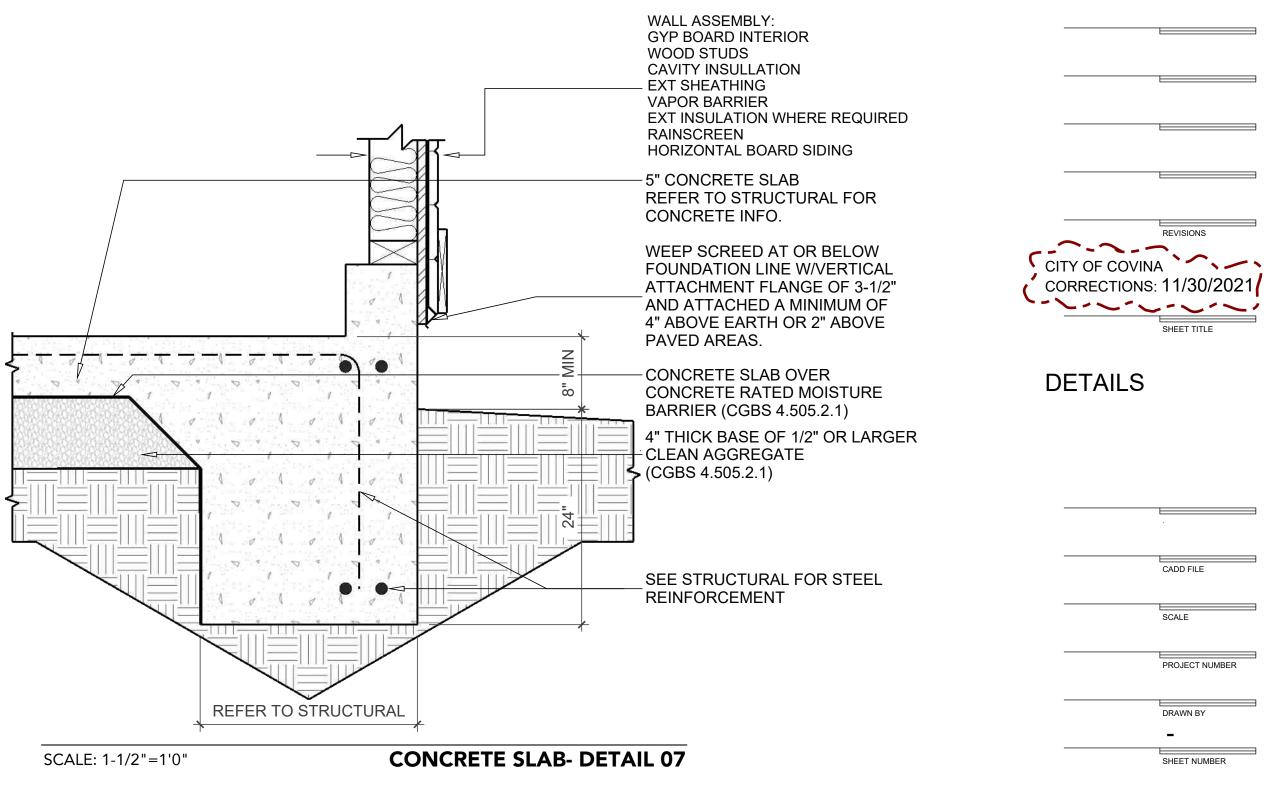

04/09/22 A 4.1

PROJECT NUMBER

DRAWN BY